AGENDA

PLANNING COMMISSION REGULAR MEETING CITY OF FARMINGTON HILLS

JULY 17, 2025 @ 7:30 P.M.

FARMINGTON HILLS CITY HALL – CITY COUNCIL CHAMBER 31555 W. ELEVEN MILE ROAD, FARMINGTON HILLS, MICHIGAN 48336

Cable TV: Spectrum – Channel 203; AT&T – Channel 99
YouTube Channel: https://www.youtube.com/user/FHChannel8
www.fhgov.com (248) 871-2540

- 1. Call Meeting to Order
- 2. Roll Call
- 3. Approval of Agenda
- 4. Regular Meeting

A. REVISED SITE PLAN 60-10-2024 (PUD 5, 1993)

LOCATION: Southeast intersection of Twelve Mile Road and Investment Drive

PARCEL I.D.: 22-23-17-201-018

PROPOSAL: Construct day care center within OS-4 Office Research District

ACTION REQUESTED: Site plan approval

APPLICANT: Farmington Hills VI Corporate Investors, L.L.C. / Cunningham

Limp

OWNER: Farmington Hills VI Corporate Investors, L.L.C.

B. ADOPTION OF AMENDED BYLAWS AND RULES OF PROCEDURE

5. Approval of Minutes June 19, 2025, Regular and Special Meetings

- 6. Public Comment
- 7. Commissioner/Staff Comments
- 8. Adjournment

Respectfully Submitted,

Kristen Aspinall, Planning Commission Secretary


Staff Contact:


Erik Perdonik, AICP
City Planner
Planning and Community Development Department
(248) 871-2540

eperdonik@fhgov.com

NOTE: Anyone planning to attend the meeting who has need of special assistance under the Americans with Disabilities Act (ADA) is asked to contact the City Clerk's Office at (248) 871-2410 at least two (2) business days prior to the meeting, wherein arrangements/accommodations will be made. Thank you.

Rev SP 60-10-2024 Zoning

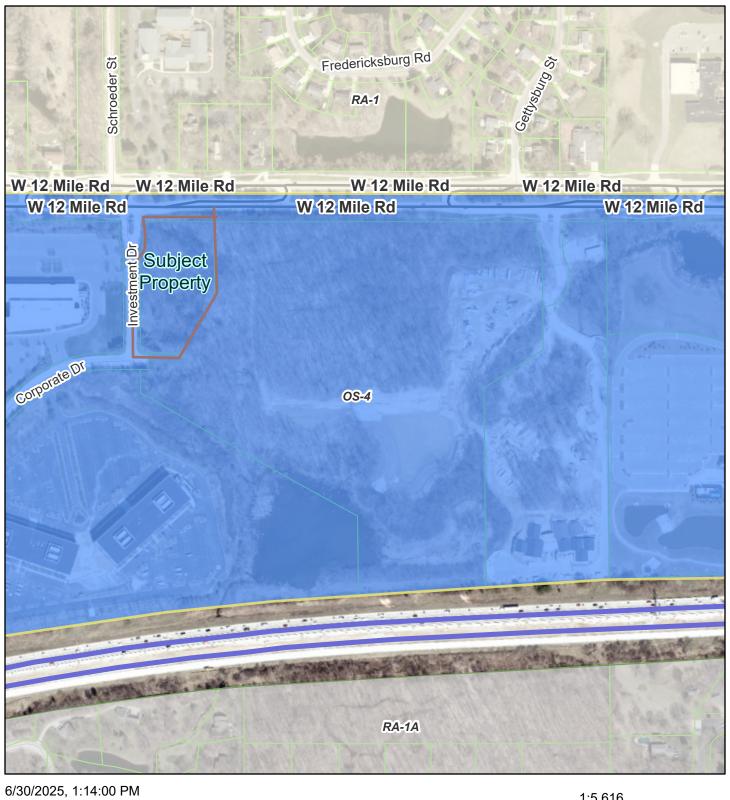

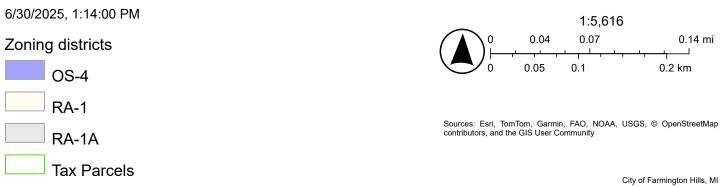


Rev SP 60-10-2024



6/30/2025, 1:17:06 PM

Tax Parcels

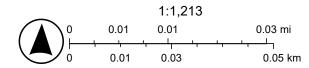

Sources: Esri, TomTom, Garmin, FAO, NOAA, USGS, \circledcirc OpenStreetMap contributors, and the GIS User Community



June 20, 2025

Farmington Hills Planning Commission 31555 W 11 Mile Rd Farmington Hills, MI 48336

Site Plan/Landscape Plan/Tree Removal

Case: PUD 5, 1993/Revised SP 60-10-2024

Site: 12 Mile & Investment Drive

Applicant: Michael Lawrence

Plan Date: 06/06/2025 Zoning: 05-4 w/ PUD

We have completed a review of the application for PUD amendment referenced above and a summary of our findings is below. Items in **bold** require specific action by the Applicant. Items in *italics* can be addressed administratively.



SUMMARY OF FINDINGS

Existing Conditions

- 1. **Zoning.** The site is zoned OS-4 and is part of PUD 5, 1993.
- 2. **Existing site.** The total site (parcel 23-17-201-014) is 31.18 acres. The portion of the overall PUD being considered for site plan approval here is 2.59 acres and is undeveloped. A lot split for this portion of the parent parcel was approved by the Planning Commission during the November 21, 2024 Planning Commission meeting, but has not been recorded yet. During this meeting, the Planning Commission also approved a site plan proposal for a day care center. The larger portion of the parent parcel (parcel A) has an approved site plan for a large office development.

3. Adjacent Properties.

Direction	Zoning	Land Use
North (across 12 Mile)	RA-1 One-Family	Single family homes
East	OS-4 w/ PUD	Approved large office site plan
South	OS-4 w/ PUD	I-696
West	OS-4 w/ PUD	Large office

4. **Site configuration and access.** The site is proposed to be accessed from a driveway off Investment Drive.

5. PUD Agreement and Use

The applicant proposes a day care use. The existing agreement for PUD 5, 1993, permits child care uses.

6. Site Plan & Use:

The applicant is proposing a child care center within the larger, office-focused PUD. The development consists of one 10,000-square-foot building with access from Investment Dr. The planning commission approved a site plan and lot split for this proposed development during the November 21, 2024, Planning Commission meeting. The split has not yet been recorded.

This application proposes the following amendments to the site plan:

- i. Relocation of dumpster enclosure (as noted as required administrative condition in 11/21/2024 approval)
- ii. Change from 42 to 40 parking spaces
- iii. Grading and retaining wall design
- iv. Adjustments to landscaping
- v. Elimination of sidewalk (Requires waiver- major amendment)
- 7. **Summary of Approved Split.** The split (approved November 2024) will result in two parcels:
 - a. **Parcel A.** 28.59 acres; this is the large remainder with the approved large office site plan.
 - b. **Parcel B.** 2.59 acres; the day care site plan is proposed for this site.
- 8. **Site configuration and access.** Access will be from Investment Drive (unchanged from original approval)

9. Dimensional Standards. The OS-4 district does not have a minimum lot size or minimum lot width.

Item	Required	Proposed/Comments
Min. lot size		
Min. lot width		
Front Setback (west)	50 ft	81.92 ft
Rear Setback (east)	40 ft	103.62 ft
Side Setback (north)	40 ft from 12 Mile	116.59 ft
Side Setback (south)	40 ft from Corporate Drive	228.11 ft
Building Height	50 feet	26 ft
Yard landscaping (34-3.5.2.A)	For all uses except one-family detached residential units, landscaping of all yards abutting a street shall be provided	See landscaping comments below.
Front yard open space	50%	69%
Lot Coverage	Limited to 30% by PUD	Approx. 9%
Loading space (34-3.5.4)	Not required for this use	Compliant
Rooftop equipment (34-3.5.2.U.)	Rooftop equipment shall be screened in accordance with Section 34-5.17.	No information provided; rooftop equipment not indicated; appears parapets fulfill this requirement.
Landscape area abutting street or freeway (34-3.5.2.V.)	A landscaped area not less than ten (10) feet deep	13.42 ft; Compliant

10. Dumpster (34-5.1.2.D).

Item	Required	Proposed/Comments
Location	Rear yard or interior side yard;	The dumpster enclosure was
Location	accessible	relocated from the front yard to
Screening	Permanent building wall or earth	an interior side yard, and meets
	mound not less than 6 feet or 1 foot	the standards of Section 34-
	above the enclosed dumpster	5.1.2.D. However, a truck
	whichever is greater	turning template shall be
Setback	20 feet from any residential property	provided to verify that the
		location is accessible to a
		garbage vehicle.

- 11. Mechanical Equipment (34-5.1.4.D). Mechanical equipment is not addressed on the plan.
- 12. Fences (34-5.12.2.) and Walls (34-5.15.) No fences or walls are required or proposed, except that a fenced outdoor play area is provided in compliance with state rules and the retaining wall was modified to protect the surrounding wetlands/ topography.
- 13. **Minimum parking (34-5.2.11.B.iii).** Parking is required as follows (ufa = usable floor area):

Use	Requirement	Calculation	Provided
	1 space per employee	158 pupils = 16	40
Child care	and 1 space per 10	20 teachers, 2 admin staff = 22	(Changed
	pupils	Total = 38	from 42).

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- 14. **Parking Location.** Parking is located in compliance with the ordinance.
- 15. Off-street parking dimensions (34-5.3.3.A & B.). The spaces meet the minimum requirements.

Item	Required	Proposed/Comments
Maneuvering lane width	20 ft for 90-degree parking (per PUD)	20 ft
Parking space width	9 ft.	9 ft
Parking space length	20 ft. for minimum required (May include a maximum two-foot unobstructed vehicle overhang area at the front of the parking space.) 17 ft. for additional parking (May include a maximum one-foot unobstructed vehicle overhang area at the front of the parking space)	18 ft w/ 2-foot overhang (7-foot sidewalks provided)

- 16. Barrier Free Parking. Two van-accessible ADA spaces are proposed, as required.
- 17. Corner Clearance (34-5.10). This standard is met.
- 18. Landscape Development (34-5.14).

Item	Required			Proposed/Comments
Minimum distance from the property line (34-5.14.C.ii)	4 ft from the property line for trees and large shrubs		Compliant	
Minimum parking lot island area	Minimum of 180 square feet; 3 feet minimum radius at the trunk of the tree		Standard is met by all in-lot landscape areas	
Cost estimate	Not required			
Minimum size and spacing requirements	Size	Center to center distance (max)		
(34-5.14.F)	(Height/width)	groupings	rows	
• Evergreen Trees	8 ft. height	20 ft.	12 ft.	
• Narrow Evergreen Trees	5 ft. height	10 ft.	5 ft.	
 Large Shrubs 	30 in. height	10 ft.	5 ft.	
Small Shrubs	24 in. width	4 ft.	4 ft.	
Large Deciduous	3 in. caliper	30 ft.	-	Standard is met
• Small deciduous trees 2 in. caliper 15 ft				
Hedge shrubs	24 in. height	3 ft. 3 ft.		Standard is met
Canopy Trees Shall be large deciduous. PC may permit large evergreens		Standard is met		

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Item	Required	Proposed/Comments	
Minimum number of parking lot trees (34-5.14.4.C)	1 per every 2,800 square feet of paved surface area: 17,699 sq ft of paved area = 7 required trees.	11 trees provided	
Parking lot screening from public thoroughfare (34-5.14.5)	A planted hedge of small shrubs, or A masonry wall or berm 2 feet high	Compliant	
Wall or Berm (34-5.15) Required when abutting a residential district. (See 34-5.15)		Not required	
Tree replacement (34-5.18)	Per the PUD, 33% of ordinance requirement	See below	

19. Tree Replacement (34-5.18). The applicant proposes to pay into the tree fund for a portion of the required replacement trees. The development agreement allows for a reduction in overall tree replacement by 33%.

Trees Removed	Replacements Required	Replacements Provided
Regulated: 170	1:1 = 170 trees	75 trees ¹
Landmark: 2 @ 18" dbh	36 x .25 = 9 inches (3 x 3" trees)	37, 3" deciduous, 25 3" ornamental, 13, 10' evergreen
Total	173 trees+ 33% Reduction in replacements per originally approved development agreement	75 trees Deficient by 40 Applicant has requested to provide money into the tree fund
	115 trees	

Footnotes:

- 1. This application included an amendment in the number of trees provided from 87 trees to 75 trees.
- 20. **Lighting (Section 34-5.16).** The applicant did not provide an updated photometric plan. The administrative comments below were included with the original plan approval and updated photometric plans should be provided to the Farmington Hills Planning Department demonstrating compliance with all of the comments below.
 - a. **Operation hours (34-5.16.3.B.v.).** The following notes must be added to or addressed on the plan; it is unclear from the existing plans whether these standards are met. The applicant should clarify how these standards are met.
 - i. Exterior lighting shall not operate during daylight hours.
 - ii. Building façade and landscape lighting shall be turned off between midnight or one hour after close of business, whichever is later, and 6:00am or opening, whichever is earlier.
 - iii. All other exterior lighting shall be reduced to no greater than 70% of maximum from midnight or one hour after close of business, whichever is later, and 6:00am or opening, whichever is earlier.

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iv. Use of occupancy sensors to turn off or reduce lighting within 15 minutes of zero occupancy is recommended.

b. Illumination Levels

Item	Required	Proposed/Comments
Illumination Levels Building		
Entrances – within 20 ft of	Max. 2,000 lumens per door	Unclear from plan
door		

- 21. Day Care Centers (Sec. 34-4.5). The proposed center meets the standards and intent of this section.
- 22. Pedestrian Connection (Sec. 34-5.19). No sidewalk is provided along Investment Drive. The applicant is requesting a waiver from this requirement, but is providing a connection to the 12 Mile Road sidewalk.

We are available to answer questions.

Respectfully,


Giffels Webster

Joe Tangari, AICP

Principal


Julia Upfal, AICP

Senior Planner

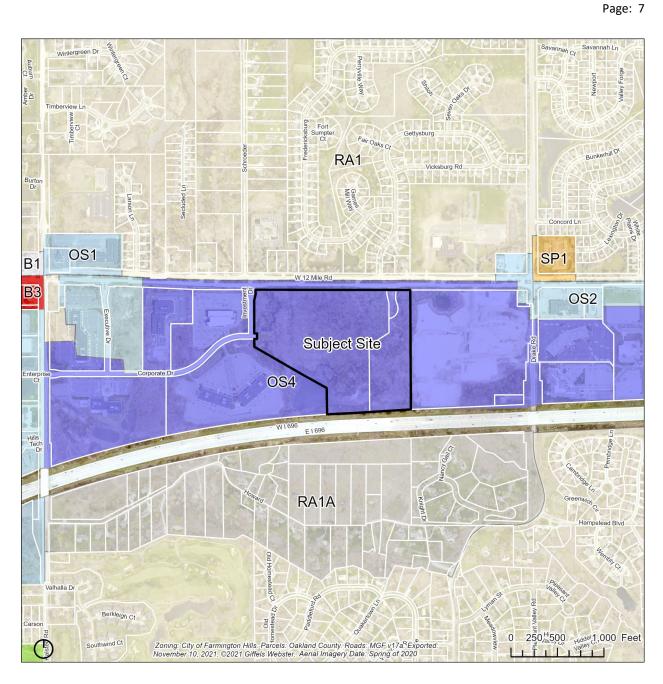

Current zoning

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DEPARTMENT OF PUBLIC SERVICES JACOB RUSHLOW, P.E., DIRECTOR

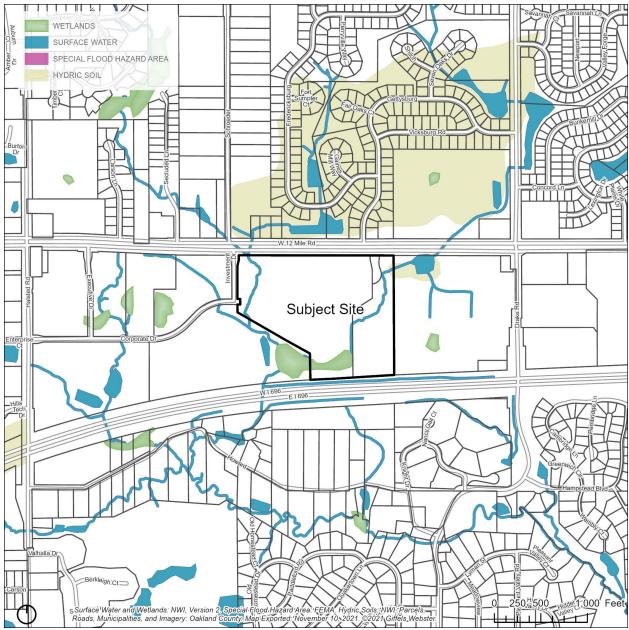INTEROFFICE CORRESPONDENCE

DATE:

June 25, 2025

TO:

Erik Perdonik, City Planner

FROM:

James Cubera, Engineering

SUBJECT:

REVISED TLE Farmington Hills Child Care Building

SP#: 60-10-2024 PJ# 17-24-44

This office has performed a preliminary review of the above referenced revised site plan submitted to the Planning Department on June 6, 2025. We have no objection to the plan as submitted. Our preliminary comments remain as per our correspondence of November 12, 2024.



INTEROFFICE CORRESPONDENCE

DATE: June 30, 2025

TO: Planning Commission

FROM: Jason Baloga, Fire Marshal

SUBJECT: Revised Site Plan 60-10-2024 (The Learning Experience) Twelve Mile Road

The Fire Department is unable to recommend approval of this site plan due to it conflicting with the following requirement:

• Site access:

a. Chapter 12, Section 12-11(1) a. of the City Ordinance – Site shall accommodate fire apparatus with a fifty-foot (50') turning radius. Generally, dead-end drives longer than one hundred (100) feet shall not be allowed.

Once the above is satisfied, the Fire Department will have no objection contingent upon compliance with the following:

- 1. Site shall comply with Chapter 12 Section 12-11 Fire Department Site Plan Review and Design Standards.
- 2. Building shall be subject to International Fire Code, Michigan Building Code, NFPA and Bureau of Fire services requirements.
- 3. Building shall be maintained in accordance with minimum Fire Prevention Code requirements.

Jason Baloga, Fire Marshal

JB/al

FARMINGTON HILLS VI CORPORATE INVESTORS, L.L.C.

39400 Woodward Avenue Bloomfield Hills, MI 48304 (248) 644-7600

Dear Members of the Planning Commission,

We are pleased to be moving forward with the development of *The Learning Experience* daycare facility in Farmington Hills. Since the initial Site Plan approval, our team has continued working closely with the City's staff to refine the project and ensure compliance with all applicable requirements.

As part of that ongoing coordination, we have made a few minor modifications to the approved Site Plan in response to comments provided in the most recent consultant review letter. Most notably, the dumpster enclosure—previously located within the front yard—has been relocated to a new position that is fully compliant with City ordinances.

In addition, we have made some minor adjustments to the overall site grading and retaining wall design. These adjustments were necessary to accommodate the topography and limit the impacts on the surrounding wetlands. As a result, the number of trees being replaced on-site has been slightly reduced; however, the site remains attractively and thoughtfully landscaped. The amount allocated to the tree fund has been appropriately adjusted to account for the required tree replacement. The visual quality of the project and its alignment with City standards for landscaping remains a top priority, especially since this project sits at the entrance to our overall office park.

We are now returning to the Planning Commission to request a modification to our previously approved Site Plan. With this request, we are seeking a waiver from the requirement to install a sidewalk along Investment Drive. After further evaluation of the area and the nature of our proposed use, we believe that this sidewalk segment is not necessary for the following reasons:

- 1. The Use Does Not Generate Pedestrian Traffic: As a daycare facility, the children are dropped off by their parents via car, primarily on their way to work. There is very little—if any—demand for pedestrian access between our building and 12 mile road, but we have provided for this connection in the updated site plan. There is no need for additional sidewalk along Investment Drive adjacent to our site.
- 2. Lack of Existing Sidewalk Network: There are currently no existing sidewalks within the entire Farmington Hills Corporate Campus office park, and a sidewalk along our frontage would not connect to any other pedestrian facilities. Installing a sidewalk would not provide meaningful connectivity or improve pedestrian access to other properties in the park.
- 3. Pedestrian Access to 12 Mile Road: We are meeting the intent of the ordinance by providing pedestrian connectivity from our building to 12 Mile Road. This connection ensures that pedestrian access is accommodated, while avoiding unnecessary construction that offers no immediate utility to the overall park.

We remain committed to developing a high-quality, safe, and attractive facility that meets the needs of local families and reflects the standards of the City of Farmington Hills. We appreciate the Planning Commission's consideration of our request for a Site Plan modification and the associated waiver, and we look forward to continuing to work together on the successful completion of this project.

Sincerely,

FARMINGTON HILLS VI CORPORATE INVESTORS, L.L.C.,

a Michigan limited liability company

By: KOJAIAN FARMINGTON HILLS VI CORPORATE INVESTORS-MM, INC.,

a Michigan corporation

Its: Manager

Christopher J. Kojaian

Its: Senior Vice President



June 16, 2025

Farmington Hills Planning Commission City of Farmington Hills 31555 W. Eleven Mile Road Farmington Hills, MI 48336

Dear Members of the Planning Commission,

On behalf of The Learning Experience, we are writing to express our support for the request to waive the requirement to install a sidewalk along Investment Drive as part of our new daycare facility development.

As a childcare provider, our operations are centered around vehicular drop-off and pick-up. Parents and guardians arrive by car, park briefly, and escort their children into the building. There is no pedestrian traffic associated with our use, and we do not anticipate that changing in the future.

Furthermore, there are currently no existing sidewalks along Investment Drive or within the surrounding office park that would connect to our property. As such, the installation of a sidewalk along our frontage would not provide meaningful pedestrian connectivity or serve a functional purpose. That said, we are proposing the installation of a sidewalk connecting our site to 12 Mile Road in order to satisfy the intent of the ordinance.

We are also pleased to share that we have signed a 20-year lease for this location, with renewal rights, and look forward to being a part of this great community for many years to come. Our long-term commitment reflects our enthusiasm and confidence in becoming a trusted and contributing member of the Farmington Hills community.

We respectfully ask the Planning Commission to consider our unique use and the context of the area and approve the requested waiver from the sidewalk installation requirement along Investment Drive.

Thank you for your time and consideration.

Sincerely,

Nick Vanella Executive Vice President – Real Estate The Learning Experience


TLE FARMINGTON HILLS

12 MILE ROAD & INVESTMENT DRIVE FARMINGTON HILLS, OAKLAND COUNTY, MI



PERMIT / APPROVAL SUMMARY			
DATE SUBMITTED	DATE APPROVED	PERMIT / APPROVAL	
02/21/25		CITY ENGINEERING APPROVAL	
05/02/25		CITY ROW PERMIT	
05/02/25		CITY SOIL EROSION PERMIT	
02/21/25		O.C.W.R.C. APPROVAL (VIA CITY SUBMITTAL)	
05/02/25		R.C.O.C. APPROVAL	
05/02/25		EGLE PUBLIC WATER MAIN PERMIT (VIA CITY)	
04/22/25		EGLE WETLAND PERMIT	



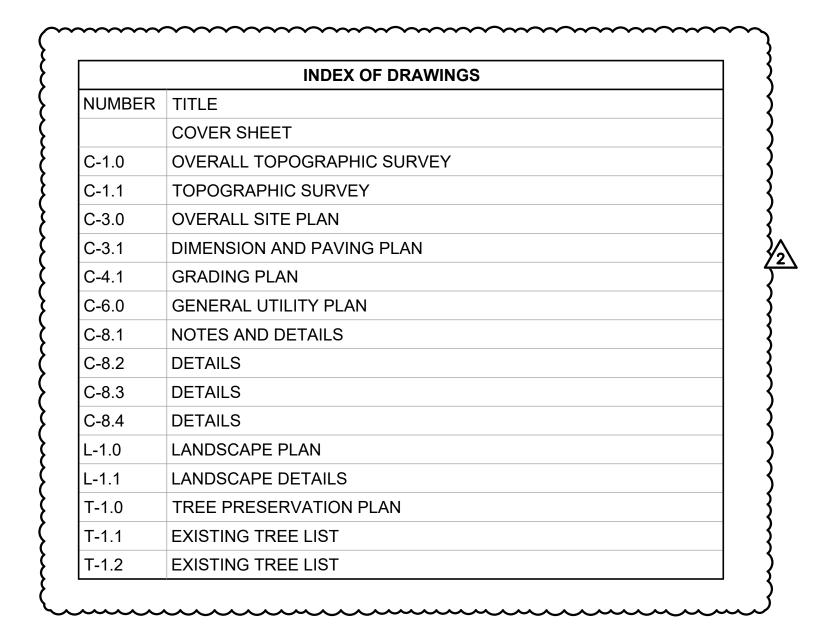

DESIGN TEAM

OWNER/APPLICANT/DEVELOPER

FARMINGTON HILLS VI CORPORATE INVESTORS, LLC
39400 WOODWARD AVENUE, STE. 250
BLOOMFIELD HILLS, MI 48304
CONTACT: ANTHONY ANTONE
PHONE: 248-644-7600
EMAIL: TANTONE@KOJAIAN.COM
PEA GROUP
1849 POND R
AUBURN HILL
CONTACT: JO
PHONE: 844.8
EMAIL: JHOUS

ARCHITECT LANDS

JARMEL KIZEL ARCHITECTS AND ENGINEERING INC.
42 OKNER PARKWAY
LIVINGSTON, NEW JERSEY 07039
CONTACT: CHERYL SCHWEIKER, AIA
PHONE: 973.994.9669
EMAIL: CSCHWEIKER@JKARCH.COM


CIVIL ENGINEER


PEA GROUP 1849 POND RUN AUBURN HILLS, MI 48326 CONTACT: JOHN HOUSER, PE PHONE: 844.813.2949 EMAIL: JHOUSER@PEAGROUP.COM


LANDSCAPE ARCHITECT

PEA GROUP
7927 NEMCO WAY, STE. 115
BRIGHTON, MI 48116
CONTACT: JANET EVANS, PLA
PHONE: 844.813.2949
EMAIL: JEVANS@PEAGROUP.COM

PENAL SERVICE OF THE PROPERTY OF THE PROPERTY

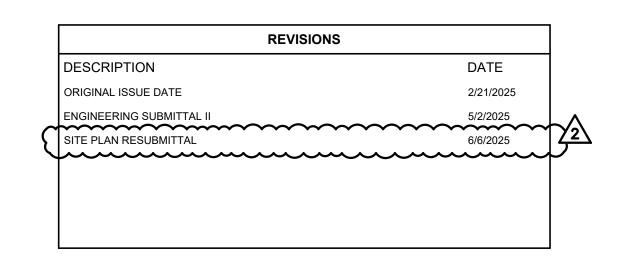

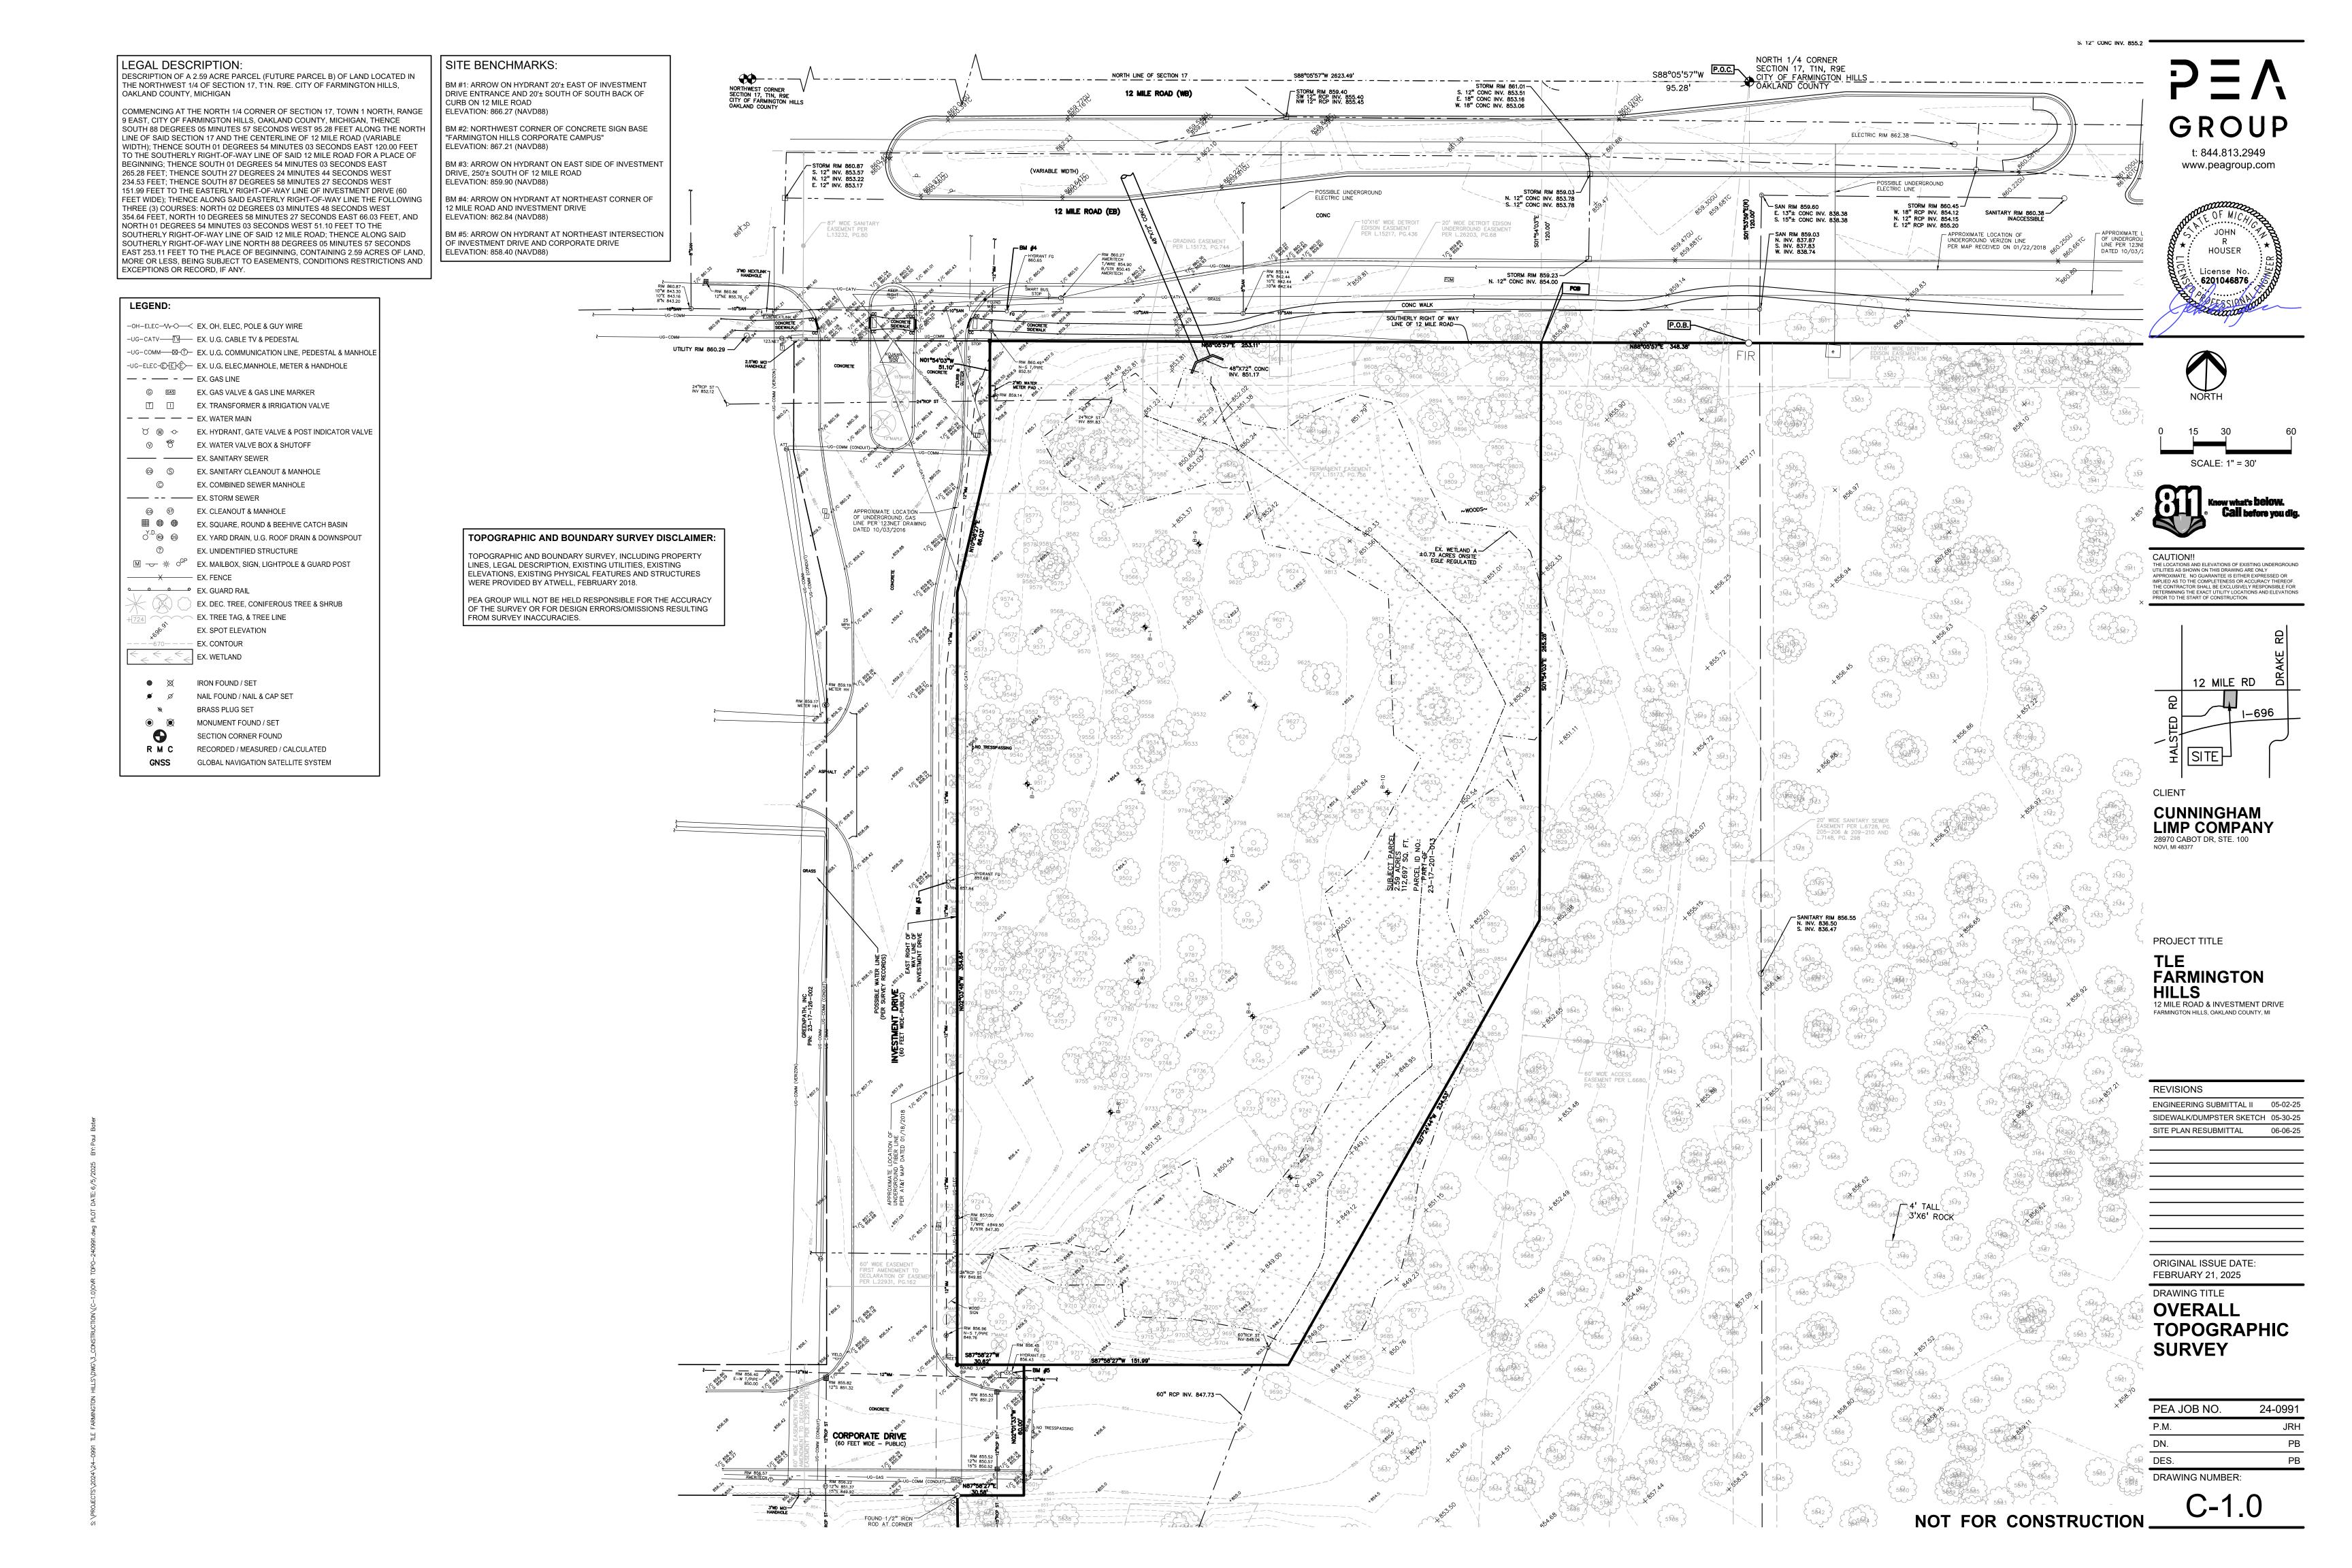

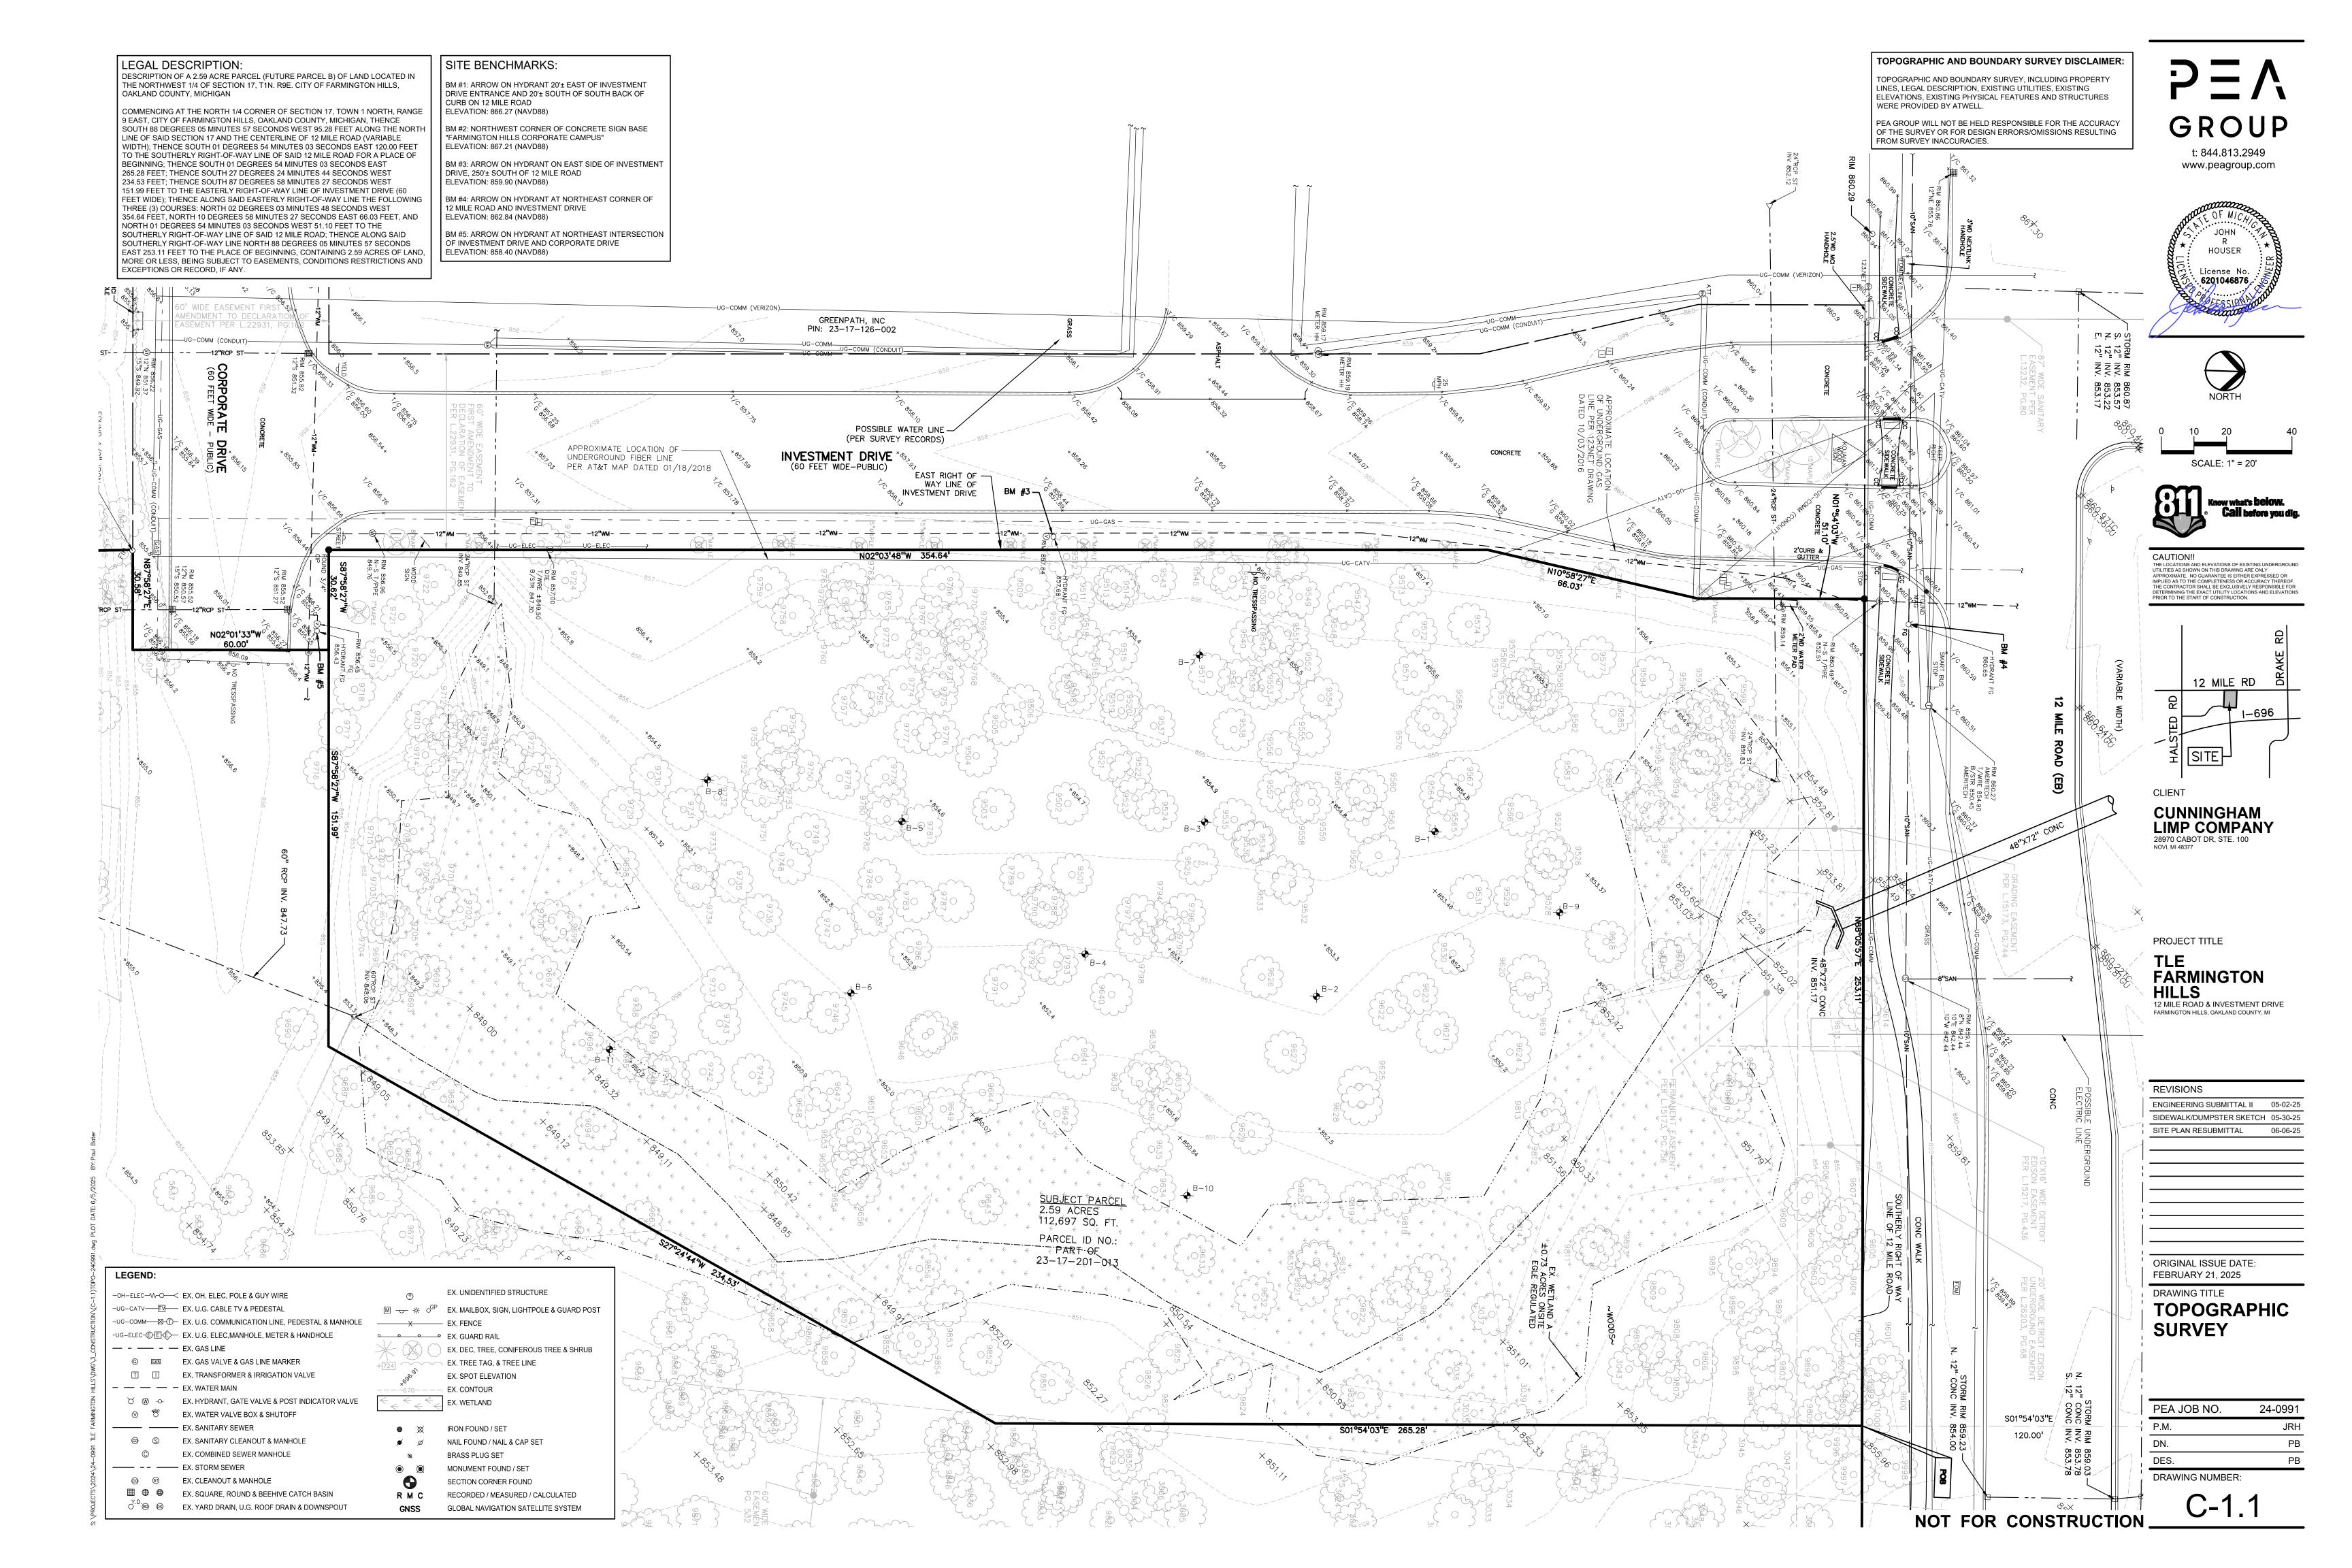

LEGAL DESCRIPTION:

DESCRIPTION OF A 2.59 ACRE PARCEL (FUTURE PARCEL B) OF LAND LOCATED IN THE NORTHWEST 1/4 OF SECTION 17, T1N. R9E. CITY OF FARMINGTON HILLS, OAKLAND COUNTY, MICHIGAN

COMMENCING AT THE NORTH 1/4 CORNER OF SECTION 17, TOWN 1 NORTH, RANGE 9 EAST, CITY OF FARMINGTON HILLS, OAKLAND COUNTY, MICHIGAN, THENCE SOUTH 88 DEGREES 05 MINUTES 57 SECONDS WEST 95.28 FEET ALONG THE NORTH LINE OF SAID SECTION 17 AND THE CENTERLINE OF 12 MILE ROAD (VARIABLE WIDTH); THENCE SOUTH 01 DEGREES 54 MINUTES 03 SECONDS EAST 120.00 FEET TO THE SOUTHERLY RIGHT-OF-WAY LINE OF SAID 12 MILE ROAD FOR A PLACE OF BEGINNING; THENCE SOUTH 01 DEGREES 54 MINUTES 03 SECONDS EAST 265.28 FEET; THENCE SOUTH 27 DEGREES 24 MINUTES 44 SECONDS WEST 234.53 FEET: THENCE SOUTH 87 DEGREES 58 MINUTES 27 SECONDS WEST 151.99 FEET TO THE EASTERLY RIGHT-OF-WAY LINE OF INVESTMENT DRIVE (60

FEET WIDE); THENCE ALONG SAID EASTERLY RIGHT-OF-WAY LINE THE FOLLOWING THREE (3) COURSES: NORTH 02 DEGREES 03 MINUTES 48 SECONDS WEST 354.64 FEET, NORTH 10 DEGREES 58 MINUTES 27 SECONDS EAST 66.03 FEET, AND SOUTHERLY RIGHT-OF-WAY LINE OF SAID 12 MILE ROAD; THENCE ALONG SAID SOUTHERLY RIGHT-OF-WAY LINE NORTH 88 DEGREES 05 MINUTES 57 SECONDS EAST 253.11 FEET TO THE PLACE OF BEGINNING, CONTAINING 2.59 ACRES OF LAND, MORE OR LESS, BEING SUBJECT TO EASEMENTS, CONDITIONS RESTRICTIONS AND

SITE BENCHMARKS:

BM #1: ARROW ON HYDRANT 20'± EAST OF INVESTMENT DRIVE ENTRANCE AND 20'± SOUTH OF SOUTH BACK OF CURB ON 12 MILE ROAD ELEVATION: 866.27 (NAVD88)

BM #2: NORTHWEST CORNER OF CONCRETE SIGN BASE "FARMINGTON HILLS CORPORATE CAMPUS"

BM #3: ARROW ON HYDRANT ON EAST SIDE OF INVESTMENT DRIVE, 250'± SOUTH OF 12 MILE ROAD ELEVATION: 859.90 (NAVD88)

BM #4: ARROW ON HYDRANT AT NORTHEAST CORNER OF 12 MILE ROAD AND INVESTMENT DRIVE ELEVATION: 862.84 (NAVD88)

BM #5: ARROW ON HYDRANT AT NORTHEAST INTERSECTION OF INVESTMENT DRIVE AND CORPORATE DRIVE ELEVATION: 858.40 (NAVD88)

GENERAL NOTES:

EXCEPTIONS OR RECORD, IF ANY.


THESE NOTES APPLY TO ALL CONSTRUCTION ACTIVITIES ON THIS PROJECT.

- ALL CONSTRUCTION, WORKMANSHIP AND MATERIALS SHALL BE IN ACCORDANCE WITH CURRENT OSHA, MDOT AND MUNICIPALITY STANDARDS AND REGULATIONS.
- 2. THE CONTRACTOR SHALL NOTIFY THE CITY ENGINEER AND/OR THE AUTHORITY HAVING JURISDICTION 3 BUSINESS DAYS PRIOR TO THE BEGINNING OF CONSTRUCTION.
- THE CONTRACTOR SHALL CONTACT THE ENGINEER SHOULD THEY ENCOUNTER ANY DESIGN ISSUES DURING CONSTRUCTION. IF THE CONTRACTOR MAKES DESIGN MODIFICATIONS WITHOUT THE WRITTEN DIRECTION OF THE DESIGN ENGINEER, THE CONTRACTOR DOES SO AT HIS OWN RISK.
- UNLESS OTHERWISE AGREED UPON BETWEEN THE OWNER AND CONTRACTOR, THE CONTRACTOR SHALL PAY ALL MUNICIPAL, COUNTY, AND STATE PERMIT, INSPECTION, AND/OR TESTING FEES. THE CONTRACTOR SHALL ALSO PROVIDE THE NECESSARY BONDS AND INSURANCE REQUIRED TO COMPLETE THE PROJECT
- THE CONTRACTOR SHALL NOTIFY THE APPROPRIATE 811/ONE CALL UTILITY LOCATING CENTER, THE CITY ENGINEER AND/OR THE AUTHORITY HAVING JURISDICTION 3 BUSINESS DAYS PRIOR TO THE BÉGINNING OF CONSTRUCTION. IF NO NOTIFICATION IS GIVEN AND DAMAGE RESULTS, SAID DAMAGE WILL BE REPAIRED AT SOLE EXPENSE OF THE CONTRACTOR. IF EXISTING UTILITY LINES ARE ENCOUNTERED THAT CONFLICT IN LOCATION WITH NEW CONSTRUCTION, THE CONTRACTOR SHALL NOTIFY THE DESIGN ENGINEER SO THAT THE CONFLICT MAY BE RESOLVED.
- . CONTRACTOR SHALL VERIFY THAT THE PLANS AND SPECIFICATIONS ARE THE VERY LATEST PLANS AND SPECIFICATIONS AND FURTHERMORE, VERIFY THAT THESE PLANS AND SPECIFICATIONS HAVE BEEN APPROVED. ALL ITEMS CONSTRUCTED BY THE CONTRACTOR PRIOR TO RECEIVING FINAL APPROVAL, HAVING TO BE ADJUSTED OR RE-DONE, SHALL BE AT THE CONTRACTORS EXPENSE. SHOULD THE CONTRACTOR ENCOUNTER A CONFLICT BETWEEN THESE PLANS AND/OR SPECIFICATIONS, THEY SHALL SEEK CLARIFICATION IN WRITING FROM THE ENGINEER BEFORE COMMENCEMENT OF CONSTRUCTION. FAILURE TO DO SO SHALL BE AT SOLE EXPENSE TO THE
- ANY WORK WITHIN THE STREET OR HIGHWAY RIGHTS-OF-WAY SHALL BE PERFORMED IN ACCORDANCE WITH THE REQUIREMENTS OF THE AGENCIES HAVING JURISDICTION AND SHALL NOT BEGIN UNTIL ALL NECESSARY PERMITS HAVE BEEN ISSUED FOR THE
- . ALL PROPERTIES OR FACILITIES IN THE SURROUNDING AREAS, PUBLIC OR PRIVATE, DESTROYED OR OTHERWISE DISTURBED DUE TO CONSTRUCTION, SHALL BE REPLACED AND/OR RESTORED TO THE ORIGINAL CONDITION BY THE CONTRACTOR.
- . THE CONTRACTOR SHALL PROVIDE ALL NECESSARY BARRICADING, SIGNAGE, LIGHTS AND TRAFFIC CONTROL DEVICES TO PROTECT THE WORK AND SAFELY MAINTAIN TRAFFIC IN ACCORDANCE WITH LOCAL REQUIREMENTS AND THE MANUAL OF UNIFORM TRAFFIC CONTROL DEVICES (LATEST EDITION). THE DESIGN ENGINEER, OWNER, CITY AND STATE SHALL NOT BE HELD LIABLE FOR ANY CLAIMS RESULTING FROM ACCIDENTS OR DAMAGES CAUSED BY THE CONTRACTOR'S FAILURE TO COMPLY WITH TRAFFIC AND PUBLIC SAFETY REGULATIONS DURING THE CONSTRUCTION PERIOD.
- 10. THE USE OF CRUSHED CONCRETE IS PROHIBITED ON THE PROJECT WITHIN 100 FEET OF ANY WATER COURSE (STREAM, RIVER, COUNTY DRAIN, ETC.) AND LAKE, REGARDLESS OF THE APPLICATION OR LOCATION OF THE WATER COURSE OR LAKE RELATIVE TO THE PROJECT LIMITS.
- 11. IT SHALL BE THE RESPONSIBILITY OF THE CONTRACTOR TO ADJUST THE TOP OF ALL EXISTING AND PROPOSED STRUCTURES (MANHOLES, CATCH BASINS, INLETS, GATE WELLS ETC.) WITHIN GRADED AND /OR PAVED AREAS TO FINAL GRADE SHOWN ON THE PLANS. ALL SUCH ADJUSTMENTS SHALL BE INCIDENTAL TO THE JOB AND WILL NOT BE PAID FOR SEPARATELY.

TOPOGRAPHIC AND BOUNDARY SURVEY DISCLAIMER:

TOPOGRAPHIC AND BOUNDARY SURVEY, INCLUDING PROPERTY LINES, LEGAL DESCRIPTION, EXISTING UTILITIES, EXISTING ELEVATIONS, EXISTING PHYSICAL FEATURES AND STRUCTURES WERE PROVIDED BY ATWELL.

PEA GROUP WILL NOT BE HELD RESPONSIBLE FOR THE ACCURACY OF THE SURVEY OR FOR DESIGN ERRORS/OMISSIONS RESULTING FROM SURVEY INACCURACIES.

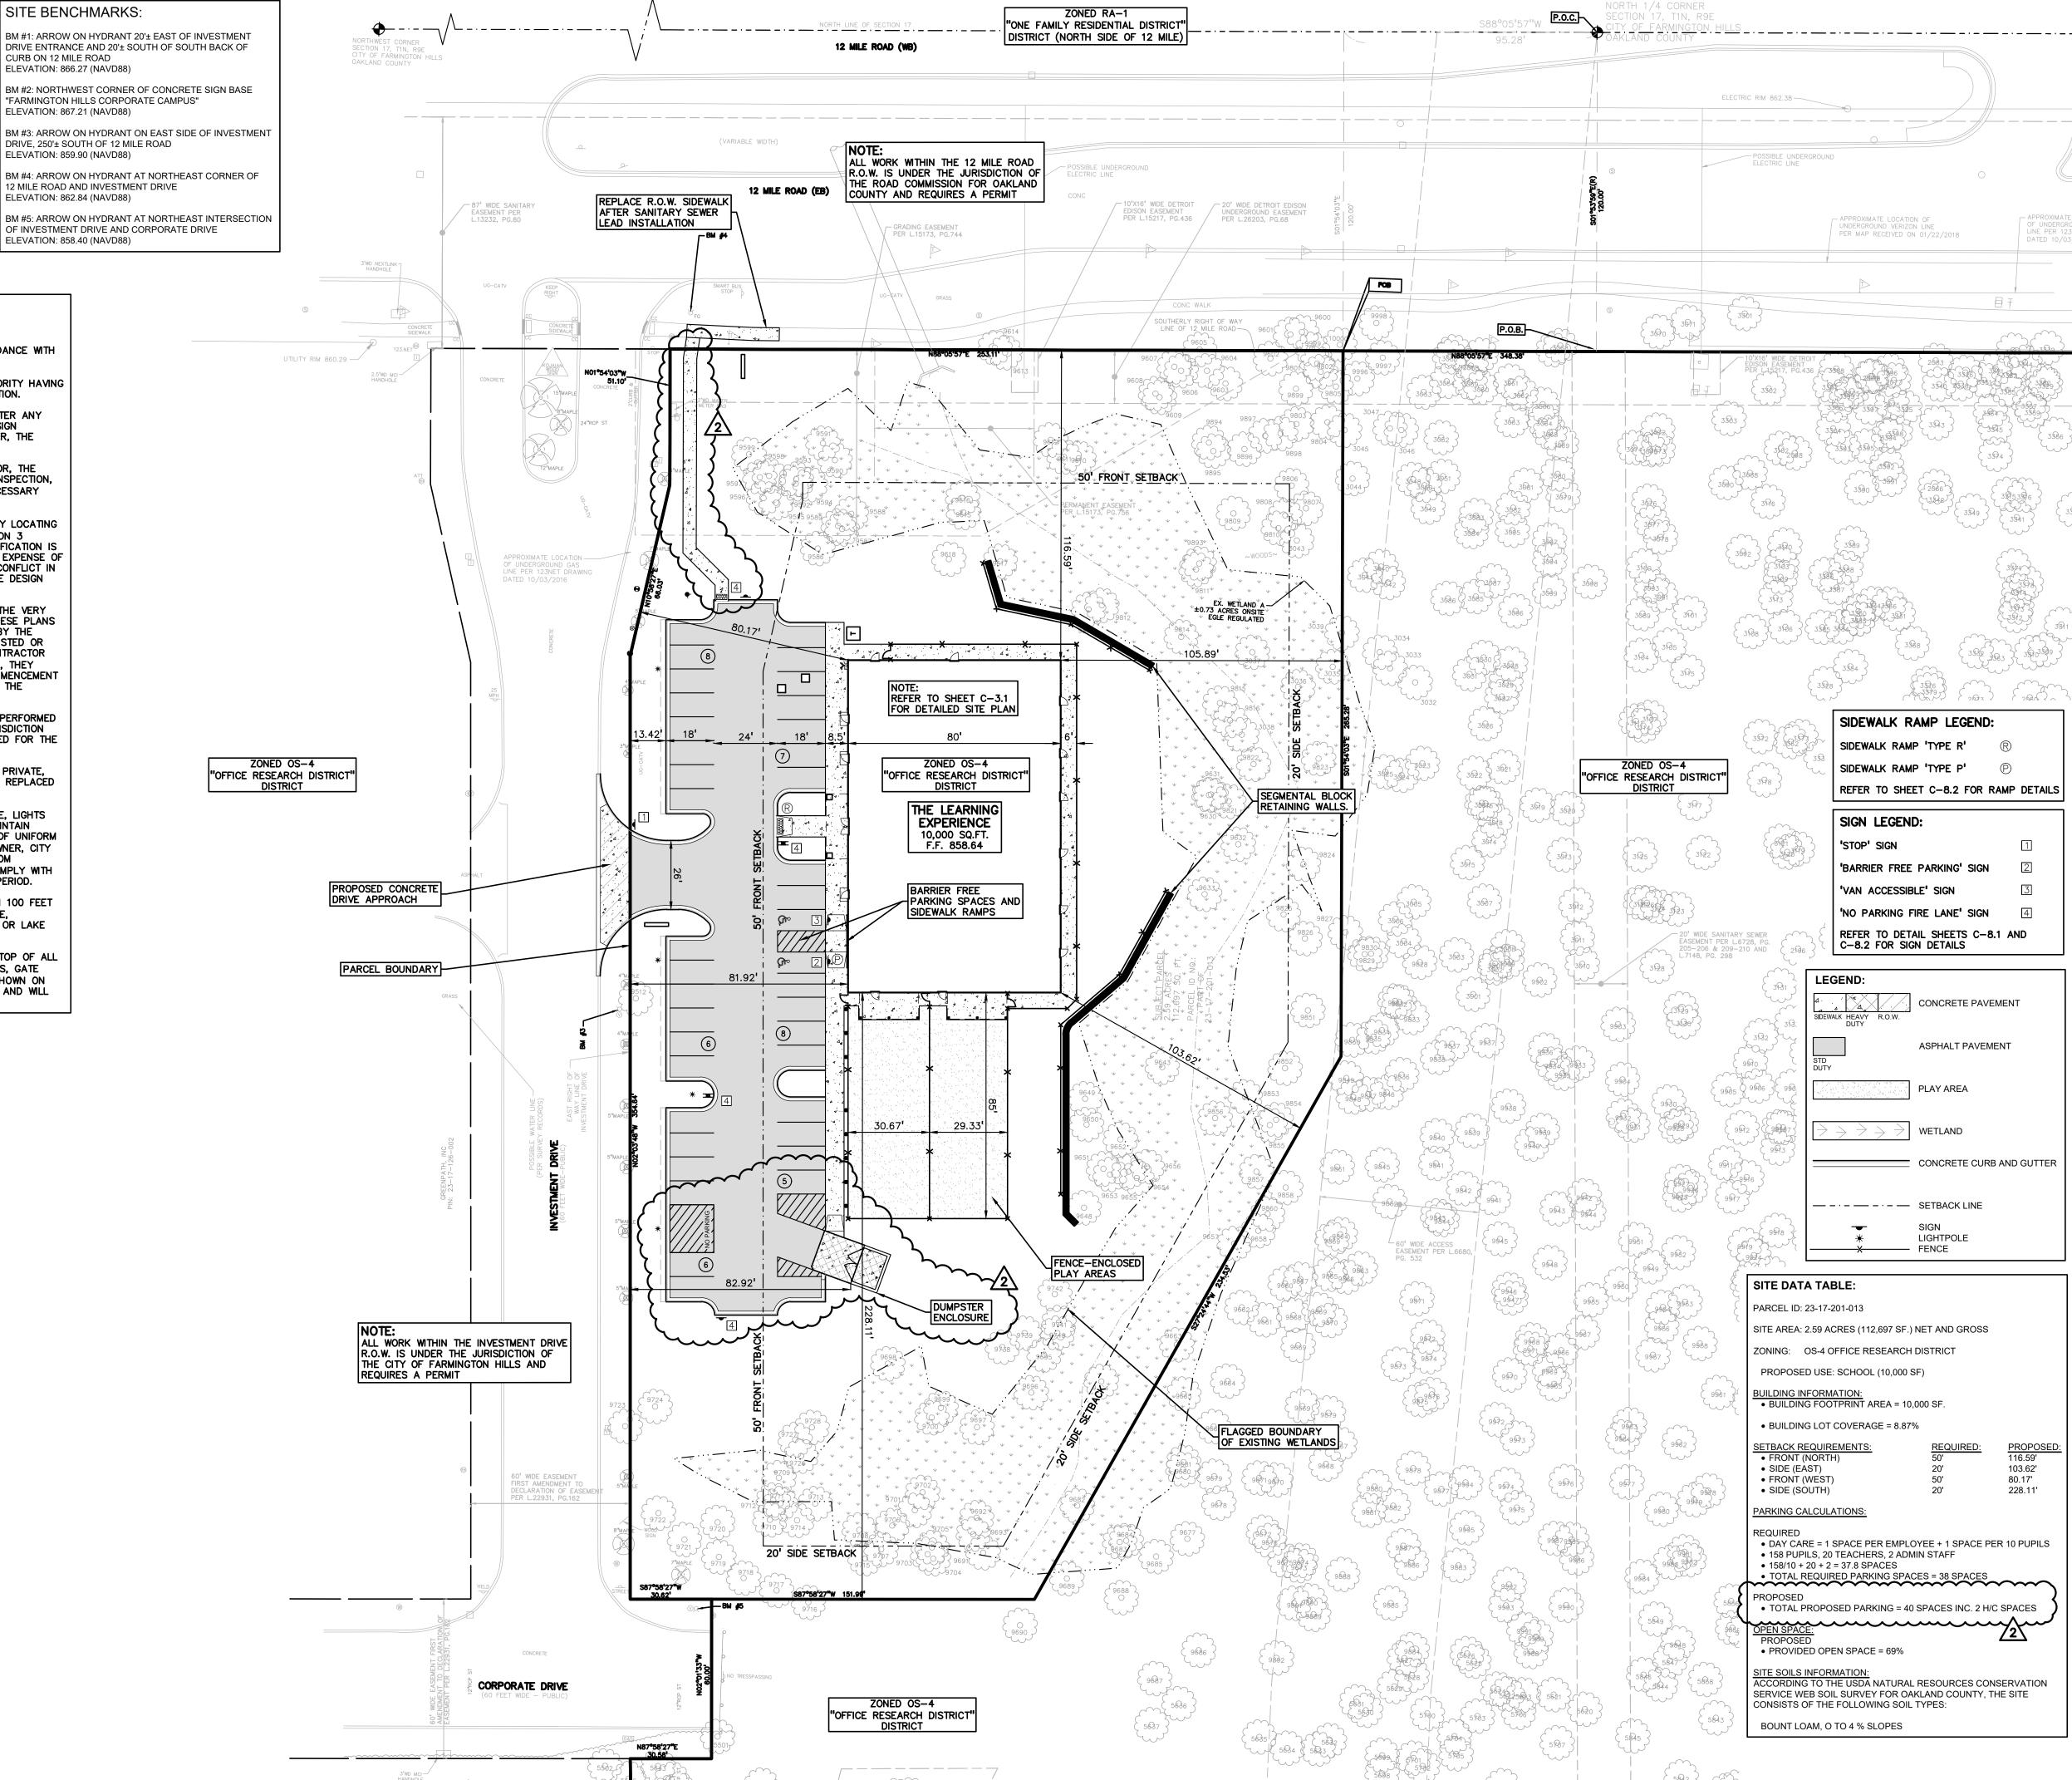

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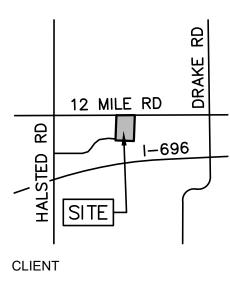


OF UNDERGROU LINE PER 123N DATED 10/03/





CAUTION!! THE LOCATIONS AND ELEVATIONS OF EXISTING UNI UTILITIES AS SHOWN ON THIS DRAWING ARE ONLY APPROXIMATE. NO GUARANTEE IS EITHER EXPRESSED OR PRIOR TO THE START OF CONSTRUCTION.



CUNNINGHAM LIMP COMPANY 28970 CABOT DR, STE. 100



		SIDEWALK/DUIVIPSTER SKETCH
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	228.11'	FEBRUARY 21, 2025
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REVISIONS


ENGINEERING SUBMITTAL II 05-02-25

05-30-25

06-06-25

DRAWING NUMBER:

TOPOGRAPHIC AND BOUNDARY SURVEY DISCLAIMER: LEGEND: SIDEWALK RAMP LEGEND: CITY OF FARMINGTON HILLS STANDARD NOTES: **LEGAL DESCRIPTION:** SITE BENCHMARKS: **GENERAL NOTES:** DESCRIPTION OF A 2.59 ACRE PARCEL (FUTURE PARCEL B) OF LAND LOCATED IN CONCRETE PAVEMENT THESE NOTES APPLY TO ALL CONSTRUCTION ACTIVITIES ON THIS PROJECT. TOPOGRAPHIC AND BOUNDARY SURVEY, INCLUDING PROPERTY SIDEWALK RAMP 'TYPE R' THE NORTHWEST 1/4 OF SECTION 17, T1N. R9E. CITY OF FARMINGTON HILLS, BM #1: ARROW ON HYDRANT 20'± EAST OF INVESTMENT THESE NOTES APPLY TO ALL CONSTRUCTION ACTIVITIES ON THIS PROJECT. LINES, LEGAL DESCRIPTION, EXISTING UTILITIES, EXISTING OAKLAND COUNTY, MICHIGAN DRIVE ENTRANCE AND 20'± SOUTH OF SOUTH BACK OF ELEVATIONS, EXISTING PHYSICAL FEATURES AND STRUCTURES NOTIFY THE CITY OF FARMINGTON HILLS ENGINEERING DIVISION AT SIDEWALK RAMP 'TYPE P' CURB ON 12 MILE ROAD ALL DIMENSIONS SHOWN ARE TO BACK OF CURB, FACE OF SIDEWALK, OUTSIDE FACE 248.871.2560 A MINIMUM OF 48 HOURS PRIOR TO THE START OF WERE PROVIDED BY ATWELL. COMMENCING AT THE NORTH 1/4 CORNER OF SECTION 17, TOWN 1 NORTH, RANGE OF BUILDING, PROPERTY LINE, CENTER OF MANHOLE/CATCH BASIN OR CENTERLINE OF ELEVATION: 866.27 (NAVD88) ASPHALT PAVEMENT SIDEWALK RAMP 'TYPE X' PIPE UNLESS OTHERWISE NOTED. 9 EAST, CITY OF FARMINGTON HILLS, OAKLAND COUNTY, MICHIGAN, THENCE PEA GROUP WILL NOT BE HELD RESPONSIBLE FOR THE ACCURACY BM #2: NORTHWEST CORNER OF CONCRETE SIGN BASE SOUTH 88 DEGREES 05 MINUTES 57 SECONDS WEST 95.28 FEET ALONG THE NORTH ALL CONSTRUCTION MUST BE CONFORMING TO THE CURRENT STANDARDS AND OF THE SURVEY OR FOR DESIGN ERRORS/OMISSIONS RESULTING REFER TO SHEET C-8.2 FOR RAMP DETAILS 'NO PARKING-FIRE LANE' SIGNS SHALL BE POSTED ALONG ALL FIRE LANES AS "FARMINGTON HILLS CORPORATE CAMPUS" LINE OF SAID SECTION 17 AND THE CENTERLINE OF 12 MILE ROAD (VARIABLE SPECIFICATIONS ADOPTED BY THE CITY OF FARMINGTON HILLS. FROM SURVEY INACCURACIES. DIRECTED BY THE FIRE OFFICIAL. WIDTH); THENCE SOUTH 01 DEGREES 54 MINUTES 03 SECONDS EAST 120.00 FEET ELEVATION: 867.21 (NAVD88) PLAY AREA TO THE SOUTHERLY RIGHT-OF-WAY LINE OF SAID 12 MILE ROAD FOR A PLACE OF 3. UTILITIES TO BE UNDERGROUND. SIGN LEGEND: BM #3: ARROW ON HYDRANT ON EAST SIDE OF INVESTMENT REFER TO SHEETS C-8.1 AND C-8.2 FOR ON-SITE PAVING DETAILS. BEGINNING; THENCE SOUTH 01 DEGREES 54 MINUTES 03 SECONDS EAST www.peagroup.com DRIVE, 250'± SOUTH OF 12 MILE ROAD 265.28 FEET; THENCE SOUTH 27 DEGREES 24 MINUTES 44 SECONDS WEST CALL MISS DIG 1.800.647.7344 A MINIMUM OF 72 HOURS PRIOR TO THE START REFER TO SHEET C-8.2 FOR ON-SITE SIDEWALK RAMP DETAILS 'STOP' SIGN 234.53 FEET: THENCE SOUTH 87 DEGREES 58 MINUTES 27 SECONDS WEST ELEVATION: 859.90 (NAVD88) WETLAND OF CONSTRUCTION. 151.99 FEET TO THE EASTERLY RIGHT-OF-WAY LINE OF INVESTMENT DRIVE (60 REFER TO SHEET C-3.0 FOR GENERAL NOTES BM #4: ARROW ON HYDRANT AT NORTHEAST CORNER OF 'BARRIER FREE PARKING' SIGN FEET WIDE); THENCE ALONG SAID EASTERLY RIGHT-OF-WAY LINE THE FOLLOWING 5. ALL SOIL EROSION AND SILT MUST BE CONTROLLED AND CONTAINED ON SITE. 12 MILE ROAD AND INVESTMENT DRIVE THREE (3) COURSES: NORTH 02 DEGREES 03 MINUTES 48 SECONDS WEST CONCRETE CURB AND GUTTER ELEVATION: 862.84 (NAVD88) 354.64 FEET, NORTH 10 DEGREES 58 MINUTES 27 SECONDS EAST 66.03 FEET, AND 'VAN ACCESSIBLE' SIGN 6. ALL EXCAVATION UNDER OR WITHIN 3 FEET OF PUBLIC PAVEMENT, EXISTING OR NORTH 01 DEGREES 54 MINUTES 03 SECONDS WEST 51.10 FEET TO THE REVERSE GUTTER PAN PROPOSED, SHALL BE BACKFILLED AND COMPACTED WITH SAND (CLASS II BM #5: ARROW ON HYDRANT AT NORTHEAST INTERSECTION SOUTHERLY RIGHT-OF-WAY LINE OF SAID 12 MILE ROAD; THENCE ALONG SAID 'NO PARKING FIRE LANE' SIGN OF INVESTMENT DRIVE AND CORPORATE DRIVE SOUTHERLY RIGHT-OF-WAY LINE NORTH 88 DEGREES 05 MINUTES 57 SECONDS HOUSER EAST 253.11 FEET TO THE PLACE OF BEGINNING, CONTAINING 2.59 ACRES OF LAND. ELEVATION: 858.40 (NAVD88) REFER TO DETAIL SHEETS C-8.1 AND THE CONTRACTOR IS RESPONSIBLE FOR ALL DAMAGE TO EXISTING UTILITIES. C-8.2 FOR SIGN DETAILS MORE OR LESS, BEING SUBJECT TO EASEMENTS, CONDITIONS RESTRICTIONS AND SIGN EXCEPTIONS OR RECORD, IF ANY. LIGHTPOLE License N PRIOR TO THE ISSUANCE OF AN OCCUPANCY PERMIT, ENGINEERING SITE **FENCE** 6201046876 INSPECTION IS REQUIRED. ALL WORK WITHIN THE INVESTMENT DRIVE 60' WIDE EASEMENT FIRST R.O.W. IS UNDER THE JURISDICTION OF GREENPATH, INC. THE CITY OF FARMINGTON HILLS AND REQUIRES A PERMIT STANDARD PARKING SPACES TO BE MARKED USING 4" WHITE STRIPING, TYP. R.O.W. CONCRETE DRIVE END OF AISLE PARKING APPROACH WITH 7" CURB. REFER SPACES AND 9.5' WIDE TO DETAIL ON SHEET C-8.1 TO BACK OF CURB, TYP POSSIBLE WATER LINE -LIGHTPOLE AND BASE, TYP. REFER TO ARCH. PLANS SP-102 MONUMENT SIGN. AND E-500 FOR DETAILS TRANSITION CURB OVER DETAIL 'M' GUTTER PAN. REFER TO DETAIL ON SHEET C-8.1 REFER TO DETAIL ON SCALE: 1" = 20' INVESTMENT DRIVE 5' TO MATCH EXISTING ARCH. PLAN A-161 HEIGHT AND DEPTH, TYF DASHED LINE INDICATES REVERSE SLOPE CURB AND GUTTER, TYP. 18"x6" CONCRETE CURB AND CONCRETE SIDEWALK, TYP. REFER TO DETAIL ON SHEET C-8.1 WAY LINE OF REFER TO DETAIL ON GUTTER, TYP. REFER TO INVESTMENT DRIV 2' VEHICLE OVERHANG. TYP DETAIL ON SHEET C-8.1 SHEET C-8.1 FIRE HYDRANT, TYP. CAUTION!! THE LOCATIONS AND ELEVATIONS OF EXISTING UNDERGROUND UTILITIES AS SHOWN ON THIS DRAWING ARE ONLY APPROXIMATE. NO GUARANTEE IS EITHER EXPRESSED OR IMPLIED AS TO THE COMPLETENESS OR ACCURACY THEREOF. THE CONTRACTOR SHALL BE EXCLUSIVELY RESPONSIBLE FOR DETERMINING THE EXACT UTILITY LOCATIONS AND ELEVATIONS PRIOR TO THE START OF CONSTRUCTION. STANDARD DUTY ASPHALT REPLACE 5' WIDE CONCRETE PAVEMENT, TYP. REFER 1 SIDEWALK AFTER SANITARY DETAIL ON SHEET C-8.1 LEAD INSTALLATION. REFER TO DETAIL ON SHEET C-8.1 SIGN, TYP. REFER TO LEGEND THIS SHEET 60.00 PROPOSED INGRESS/EGRESS LEGEND THIS SHEET EASEMENT FOR CITY 12 MILE RD DRAINAGE INSPECTION. INTEGRAL CURB AND PROPOSED INGRESS/EGRESS SIDEWALK, TYP. REFER TO EASEMENT FOR CITY DETAIL ON SHEET C-8.1 STANDARD DUTY ASPHALT DRAINAGE INSPECTION. INDICATES PAVEMENT, TYP. REFER T DETECTABLE WARNING DETAIL ON SHEET C-8.1 CONCRETE PAD AT CLEANOUT, TYP. REFER TO ASPHALT, TYP. REFER T DETAIL ON SHEET C-8.1 DETAIL ON SHEET C-8.1 HEAVY DUTY CONCRETE CLIENT PAVEMENT, TYP. REFER 1 TEMPORARY COMING DETAIL ON SHEET C-8.1 SOON' SIGN LOCATION NOTE: **CUNNINGHAM** FLAGGED WETLAND, TYP. DO NO WORK BEYOND THIS BOUNDARY DUMPSTER ENCLOSURE. LIMP COMPANY REFER TO DETAIL ON ARCH. PLAN SP-102 ALL WORK WITHIN THE 12 MILE ROAD R.O.W. IS UNDER THE JURISDICTION OF THE ROAD COMMISSION FOR OAKLAND 28970 CABOT DR. STE. 100 INTEGRAL CURB AND SIDEWALK, TYP. REFER TO DETAIL ON SHEET C-8.1 SIDEWALK RAMP, TYP. REFER TO LEGEND COUNTY AND REQUIRES A PERMIT ON THIS SHEET. PLAY AREAS. REFER TO TRANSFORMER PAD DETAILS ON ARCH. PLAN A-151 BARRIER FREE PARKING SPACES AND SIGNS. REFER TO DETAILS ON SHEET C-8.2 BOLLARD, TYP. REFER TO DETAIL ON ARCH. GATE, TYP. REFER PLAN SP-102 TO DETAIL ON ARCH. FLAGGED WETLAND, TYP. DO NO WORK BEYOND THIS BOUNDARY PLAN A-151 GATE, TYP. REFER TO DETAIL ON ARCH. 6' VINYL FENCE. PROJECT TITLE REFER TO DETAIL OF ARCH. PLAN A-151 4' CHAIN LINK FENCE. CONCRETE SIDEWALK, TYP.
REFER TO DETAIL ON
SHEET C-8.1 REFER TO DETAIL ON ARCH. PLAN A-151 THE LEARNING PLAN A-151 **EXPERIENCE** TREX BOARD EDGING AT PERIMETER FENCING, TYP. REFER TO DETAIL ON ARCH. PLAN A-152 **FARMINGTON** 10,000 SQ.FT. F.F. 858.64 THICKENED EDGE SIDEWALK ADJACENT TO TURF AREAS, CANOPY AND COLUMNS. TYP. REFER TO DETAIL ON ARCH. PLAN A-152. 125' REFER TO ARCH. PLANS 12 MILE ROAD & INVESTMENT DRIVE FOR DETAILS. FARMINGTON HILLS, OAKLAND COUNTY, MI NOTE: TOP OF SIDEWALK GRADE TO BE 1/2" LOWER THAN F.F. ELEVATION PER ARCH. PLANS REFER TO DETAIL ON ARCH. PLAN A-151 REVISIONS ENGINEERING SUBMITTAL II 05-02-25 SIDEWALK/DUMPSTER SKETCH 05-30-25 SITE PLAN RESUBMITTAL 06-06-25 CONCRETE SIDEWALK, TYP REFER TO DETAIL ON SEGMENTAL BLOCK SHEET C-8.1 RETAINING WALL WITH 4' CHAIN LINK FENCE. REFER TO DETAILS ON SHEET C-8.1 FLAGGED WETLAND, TYP. DO NO WORK BEYOND THIS BOUNDARY FLAGGED WETLAND, TYP. DO NO WORK BEYOND THIS BOUNDARY ORIGINAL ISSUE DATE: FEBRUARY 21, 2025 DRAWING TITLE **DIMENSION** SEGMENTAL BLOCK RETAINING WALL WITH 4' **AND PAVING** CHAIN LINK FENCE. REFER TO DETAILS ON SHEET C-8.1 **PLAN** AN EGLE PERMIT WILL BE REQUIRED FOR THE PERMANENT STORM WATER OUTLET AND FOR THE TEMPORARY DISTURBANCE OF THE WETLAND DURING RETAINING WALL
CONSTRUCTION. A COPY OF THE PERMIT WILL
BE PROVIDED TO THE CITY ONCE RECEIVED. PEA JOB NO. 24-0991 S01°54'03"E DES. DRAWING NUMBER: NOT FOR CONSTRUCTION

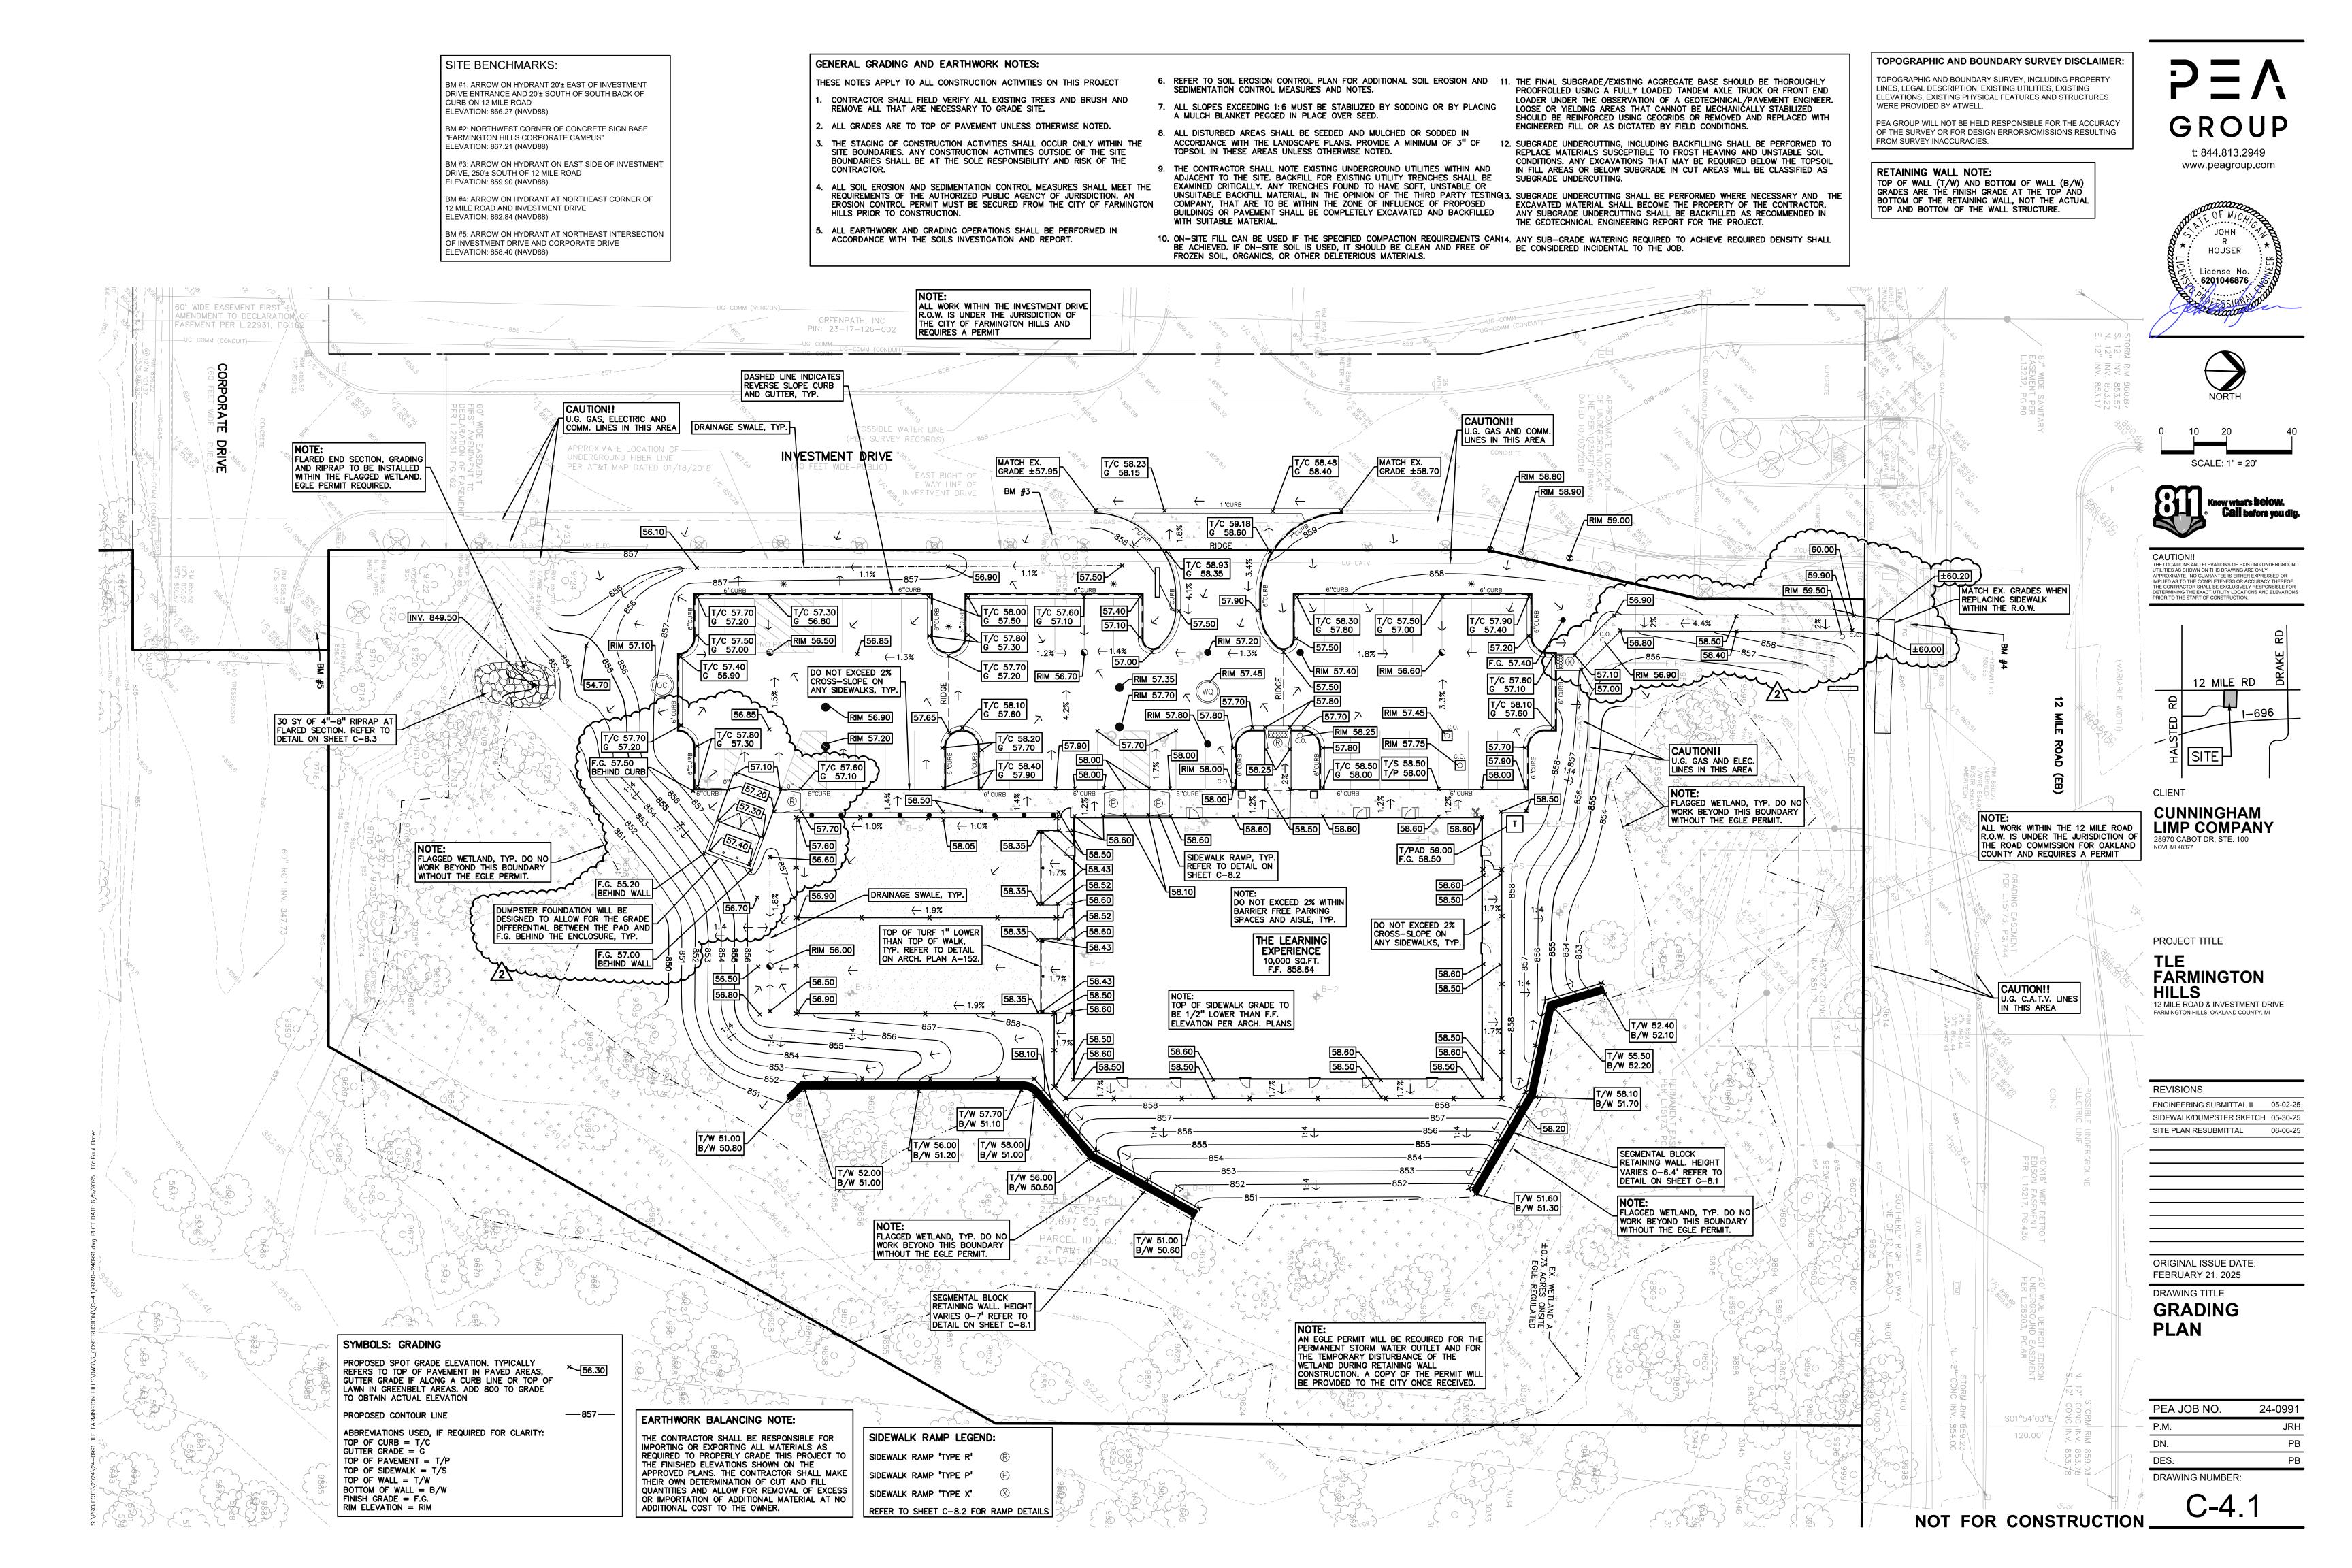

EX. HYDRANT, GATE VALVE & POST INDICATOR VALVE EX. WATER VALVE BOX & SHUTOFF

EX. SANITARY CLEANOUT & MANHOLE EX. COMBINED SEWER MANHOLE EX. STORM SEWER

EX. CLEANOUT & MANHOLE EX. SQUARE, ROUND, & BEEHIVE CATCH BASIN EX. YARD DRAIN & ROOF DRAIN

EX. UNIDENTIFIED STRUCTURE

PROPOSED HYDRANT AND GATE VALVE PROPOSED TAPPING SLEEVE, VALVE & WELL

PROPOSED POST INDICATOR VALVE PROPOSED SANITARY SEWER PROPOSED SANITARY CLEANOUT & MANHOLE PROPOSED STORM SEWER

PROPOSED STORM SEWER CLEANOUT & MANHOLE PROPOSED CATCH BASIN, INLET & YARD DRAIN

SITE BENCHMARKS:

ELEVATION: 862.84 (NAVD88)

BM #1: ARROW ON HYDRANT 20'± EAST OF INVESTMENT DRIVE ENTRANCE AND 20'± SOUTH OF SOUTH BACK OF CURB ON 12 MILE ROAD ELEVATION: 866.27 (NAVD88)

BM #2: NORTHWEST CORNER OF CONCRETE SIGN BASE "FARMINGTON HILLS CORPORATE CAMPUS" ELEVATION: 867.21 (NAVD88)

BM #3: ARROW ON HYDRANT ON EAST SIDE OF INVESTMENT DRIVE, 250'± SOUTH OF 12 MILE ROAD ELEVATION: 859.90 (NAVD88)

BM #4: ARROW ON HYDRANT AT NORTHEAST CORNER OF 12 MILE ROAD AND INVESTMENT DRIVE

BM #5: ARROW ON HYDRANT AT NORTHEAST INTERSECTION OF INVESTMENT DRIVE AND CORPORATE DRIVE ELEVATION: 858.40 (NAVD88)

TOPOGRAPHIC AND BOUNDARY SURVEY DISCLAIMER:

TOPOGRAPHIC AND BOUNDARY SURVEY, INCLUDING PROPERTY LINES, LEGAL DESCRIPTION, EXISTING UTILITIES, EXISTING ELEVATIONS, EXISTING PHYSICAL FEATURES AND STRUCTURES WERE PROVIDED BY ATWELL.

PEA GROUP WILL NOT BE HELD RESPONSIBLE FOR THE ACCURACY OF THE SURVEY OR FOR DESIGN ERRORS/OMISSIONS RESULTING FROM SURVEY INACCURACIES.

GENERAL UTILITY NOTES:

- ALL WORKMANSHIP AND MATERIALS SHALL BE IN ACCORDANCE WITH THE STANDARDS AND SPECIFICATIONS OF THE CITY OF FARMINGTON HILLS AND OAKLAND COUNTY.
- . ALL TRENCHES UNDER OR WITHIN THREE (3) FEET OR THE FORTY-FIVE (45) DEGREE ZONE OF INFLUENCE LINE OF EXISTING AND/OR PROPOSED PAVEMENT, BUILDING PAD OR DRIVE APPROACH SHALL BE BACKFILLED WITH SAND COMPACTED TO AT LEAST NINETY-FIVE (95) PERCENT OF MAXIMUM UNIT WEIGHT (ASTM D-1557). ALL OTHER TRENCHES TO BE COMPACTED TO 90% OR BETTER.
- WHERE EXISTING MANHOLES OR SEWER PIPE ARE TO BE TAPPED, DRILL HOLES 4" CENTER TO CENTER, AROUND PERIPHERY OF OPENING TO CREATE A PLANE OF WEAKNESS JOINT BEFORE BREAKING SECTION OUT.
- THE LOCATIONS AND DIMENSIONS SHOWN ON THE PLANS FOR EXISTING UTILITIES ARE IN ACCORDANCE WITH AVAILABLE INFORMATION WITHOUT UNCOVERING AND MEASURING. THE DESIGN ENGINEER DOES NOT GUARANTEE THE ACCURACY OF THIS INFORMATION OR THAT ALL EXISTING UNDERGROUND FACILITIES ARE SHOWN. CONTRACTOR SHALL FIELD VERIFY
- THE CONTRACTOR SHALL COORDINATE TO ENSURE ALL REQUIRED PIPES, CONDUITS, CABLES AND SLEEVES ARE PROPERLY PLACED FOR THE INSTALLATION OF GAS, ELECTRIC, PHONE, CABLE, IRRIGATION, ETC. IN SUCH A MANNER THAT WILL FACILITATE THEIR PROPER INSTALLATION PRIOR TO THE PLACEMENT OF THE PROPOSED PAVEMENT AND
- PIPE LENGTHS INDICATED ARE FROM CENTER OF STRUCTURE AND TO END OF FLARED END SECTION UNLESS NOTED
- CONTRACTOR SHALL INSPECT ALL EXISTING PUBLIC STORM SEWER, SANITARY SEWER AND WATER MAIN STRUCTURES WITHIN THE LIMITS OF CONSTRUCTION AND WITH THE GOVERNING AGENCY INSPECTOR PRIOR TO ESTABLISHING FINAL GRADE. NOTIFY THE ENGINEER, OWNER/DEVELOPER, AND GOVERNING AGENCY IF STRUCTURE IS DEEMED TO BE STRUCTURALLY UNSOUND AND/OR IN NEED OF REPAIR.
- ALL CATCH BASINS, SEWER MANHOLES, INLETS, GATE WELLS, ETC. ARE DRAWN SO THAT THE CORRECT STRUCTURE LOCATION CAN BE STAKED ASSUMING THE INSERTION POINT OF THE CAD BLOCK REPRESENTS THE CENTER OF THE CASTING/COVER, NOT NECESSARILY THE CENTER OF THE UTILITY STRUCTURE (THE CASTING AND THE STRUCTURE WILL HAVE DIFFERENT CENTERS IF ECCENTRIC CONES ARE USED IN CONSTRUCTION). IF UTILITY STRUCTURES ARE STAKED BY A SURVEYOR OTHER THAN PEA GROUP, THIS MUST BE TAKEN INTO ACCOUNT. PEA GROUP WILL NOT BE RESPONSIBLE FOR STAKING BY A THIRD PARTY.
-). ALL PROPOSED SANITARY SEWER AND WATER MAIN CONNECTIONS SHALL REQUIRE A PERMIT FROM THE OAKLAND COUNTY DEPARTMENT OF WATER RESOURCES.


STORM SEWER NOTES:

- ALL STORM SEWER 12" DIAMETER OR LARGER SHALL BE EITHER REINFORCED CONCRETE PIPE (RCP C-76) CLASS IV WITH MODIFIED TONGUE AND GROOVE JOINT WITH RUBBER GASKETS, OR POLYPROPYLENE DUAL-WALL CORRUGATED SMOOTH-LINED PIPE (A.D.S. HIGH-PERFORMANCE STORM PIPE), AS NOTED ON THE PLANS OR UNLESS SPECIFIED OTHERWISE (ASTM C-443). ALL JOINTS FOR HP-STORM PIPE SHALL BE EXTENDED BELL AND SPIGOT MEETING ASTM
- . ALL STORM SEWER LEADS SHALL BE CONSTRUCTED AT 1.00% MINIMUM SLOPE.
- 3. ALL STORM SEWER 10" OR LESS AND/OR LEADS SHALL BE SDR 26 OR AS NOTED IN THE PLANS.
- 4. JOINTS FOR P.V.C. PIPE SHALL BE ELASTOMERIC (RUBBER GASKET) AS SPECIFIED IN A.S.T.M. DESIGNATION D-3212.
- 5. BLIND TAP CONNECTIONS AS DETAILED ON THE PLANS SHALL BE MADE USING "INSERTA-TEE" FITTINGS OR APPROVED

WATER MAIN NOTES:

- ALL WATER MAIN SHALL BE INSTALLED WITH A MINIMUM COVER OF 5.5' BELOW FINISH GRADE. WHEN WATER MAINS MUST DIP TO PASS UNDER A STORM SEWER OR SANITARY SEWER, THE SECTIONS WHICH ARE DEEPER THAN NORMAL SHALL BE KEPT TO A MINIMUM LENGTH BY THE USE OF VERTICAL ELEVEN AND A QUARTER (11.25°) DEGREE BENDS, PROPERLY ANCHORED.
- . ALL TEES, BENDS, CONNECTIONS, ETC. ARE CONSIDERED INCIDENTAL TO THE JOB.
- PHYSICAL CONNECTIONS SHALL NOT BE MADE BETWEEN EXISTING AND NEW WATER MAINS UNTIL REQUIRED TESTING IS SATISFACTORILY COMPLETED.
- MAINTAIN 10' HORIZONTAL CLEARANCE BETWEEN OUTER EDGE OF WATERMAIN AND ANY SANITARY/STORM SEWER OR STRUCTURE.
- ALL SERVICE CONNECTIONS TO REQUIRE OCWRC CONNECTION PERMIT. CONNECTIONS 2" AND SMALLER TO BE PERFORMED BY OCWRC FIELD STAFF PER COUNTY STANDARDS.
- NO PHYSICAL CONNECTION TO THE EXISTING WATER MAIN CAN BE MADE UNTIL ALL NEW WATER MAIN PASSES PRESSURE AND BACTERIOLOGICAL TESTS TO THE SATISFACTION OF THE CITY.
- ALL WATER MAIN AND FITTINGS (3" DIAMETER AND LARGER) SHALL BE DUCTILE IRON, CLASS 54.
- WATER MAIN SERVICE LEADS SHALL BE TYPE 'K' ANNEALED SEAMLESS COPPER WITH FLARED FITTINGS, UNLESS
- 9. ALL FIRE HYDRANTS SHALL BE EJIW #5BR MODEL #250 PER CITY STANDARDS.
- 10. ALL HYDRANTS TO BE A MINIMUM OF 5' FROM BACK OF CURB, TYP.
- 1. ALL NECESSARY FITTINGS, THRUST BLOCKS, RESTRAINING GLANDS, BLOW OFFS, ETC. FOR WATER MAIN ARE CONSIDERED INCIDENTAL TO THIS PROJECT. THE CONTRACTOR SHALL INSTALL THESE ITEMS AS NECESSARY AND AS REQUIRED BY
- 12. THE WATER MAIN CONTRACTOR SHALL NOTIFY THE INSPECTION DEPARTMENT OF THE CITY AT LEAST THREE WORKING DAYS IN ADVANCE OF STARTING CONSTRUCTION.
- 13. UNLESS NOTED SPECIFICALLY OTHERWISE ON THE PLANS, THE DESIGN INTENT IS TO HAVE THE WATER MAIN CONSTRUCTED WITH THIS PROJECT BE INSTALLED VIA OPEN CUT TRENCH BY THE CONTRACTOR. IF THE CONTRACTOR CHOOSES A DIFFERENT METHOD OF CONSTRUCTION, OTHER THAN WHAT IS SHOWN ON THE APPROVED PLANS UPON WHICH THE PERMIT WAS GRANTED, THE CONTRACTOR WILL BE RESPONSIBLE TO CONTACT THE REGULATORY AGENCIES TO REVISE THE APPROVED PERMIT.

- DOWNSPOUTS, WEEP TILE, FOOTING DRAINS OR ANY CONDUIT THAT CARRIES STORM OR GROUND WATER SHALL NOT BE ALLOWED TO DISCHARGE INTO A SANITARY SEWER.
- . ALL SANITARY LEADS SHALL BE CONSTRUCTED AT 1.00% MINIMUM SLOPE.
- ALL SANITARY SEWER LEADS SHALL BE POLYVINYL CHLORIDE (PVC) SDR 23.5 PIPE AND FITTINGS. ALL JOINTS TO BE ELASTOMERIC GASKET JOINTS PER ASTM D3212 UNLESS OTHERWISE NOTED.
- SANITARY LEADS SHALL BE PROVIDED WITH CLEANOUTS EVERY 100 FEET AND AT EVERY BEND AS SHOWN. ALL CLEANOUTS TO BE PROVIDED WITH E.J.I.W. #1565 BOX OR EQUAL.
- STRUCTURES OVER EXISTING SEWER MUST HAVE A MONOLITHIC POURED BASE PER LATEST OCWRC STANDARDS AND

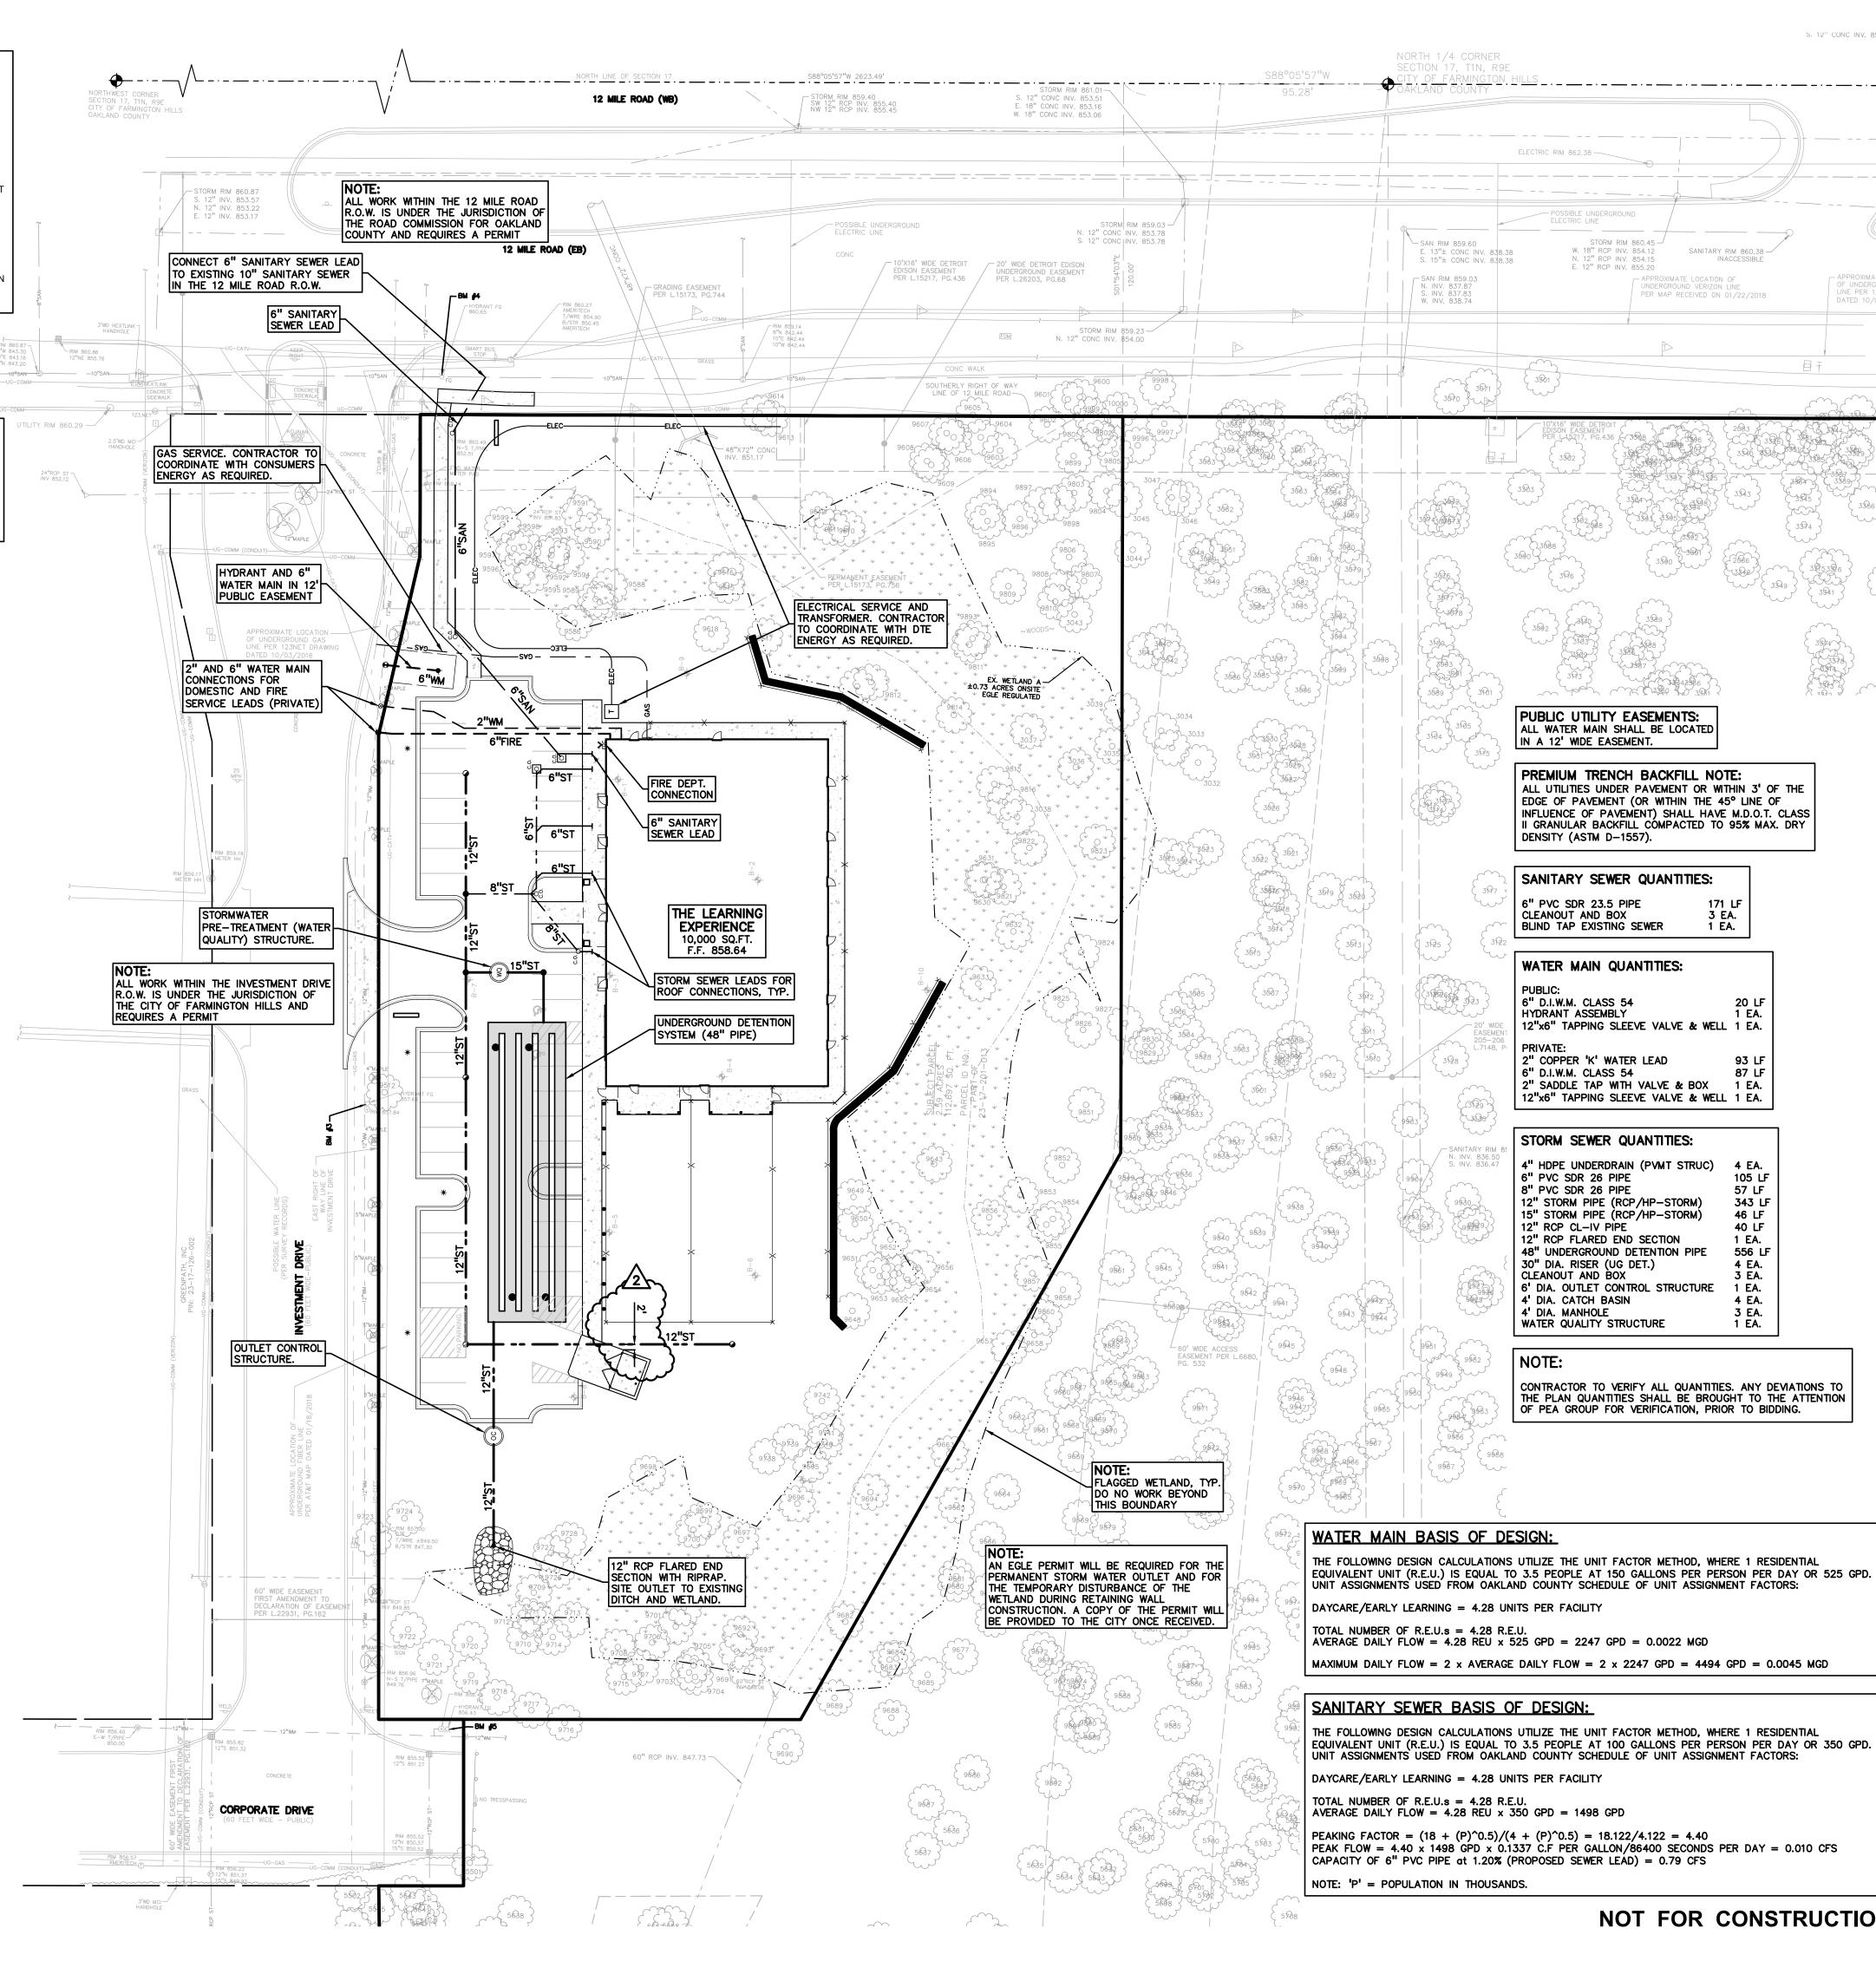

ZO AZI AND COUNTY

STORM RIM 860.45

PUBLIC UTILITY EASEMENTS:

IN A 12' WIDE EASEMENT.

DENSITY (ASTM D-1557).

CLEANOUT AND BOX BLIND TAP EXISTING SEWER

6" D.I.W.M. CLASS 54

6" D.I.W.M. CLASS 54

6" PVC SDR 26 PIPE

8" PVC SDR 26 PIPE

12" RCP CL-IV PIPE

CLEANOUT AND BOX

4' DIA. CATCH BASIN

4' DIA. MANHOLE

HYDRANT ASSEMBLY

ALL WATER MAIN SHALL BE LOCATED

SANITARY SEWER QUANTITIES:

WATER MAIN QUANTITIES:

2" COPPER 'K' WATER LEAD

12"x6" TAPPING SLEEVE VALVE & WELL 1 EA

12"x6" TAPPING SLEEVE VALVE & WELL 1 EA.

2" SADDLE TAP WITH VALVE & BOX

STORM SEWER QUANTITIES:

4" HDPE UNDERDRAIN (PVMT STRUC)

12" STORM PIPE (RCP/HP-STORM)

15" STORM PIPE (RCP/HP-STORM)

48" UNDERGROUND DETENTION PIPE

6' DIA. OUTLET CONTROL STRUCTURE

12" RCP FLARED END SECTION

30" DIA. RISER (UG DET.)

WATER QUALITY STRUCTURE

PREMIUM TRENCH BACKFILL NOTE:

ALL UTILITIES UNDER PAVEMENT OR WITHIN 3' OF THE EDGE OF PAVEMENT (OR WITHIN THE 45° LINE OF

INFLUENCE OF PAVEMENT) SHALL HAVE M.D.O.T. CLASS

II GRANULAR BACKFILL COMPACTED TO 95% MAX. DRY

1 EA.

20 LF

556 LF

1 EA.

CONTRACTOR TO VERIFY ALL QUANTITIES. ANY DEVIATIONS TO

THE PLAN QUANTITIES SHALL BE BROUGHT TO THE ATTENTION

OF PEA GROUP FOR VERIFICATION, PRIOR TO BIDDING.

PER MAP RECEIVED ON 01/22/2018


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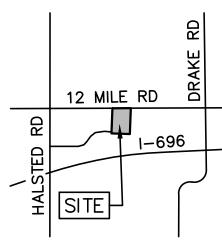


OF UNDERGROU LINE PER 123N DATED 10/03/





CAUTION!! THE LOCATIONS AND ELE JTILITIES AS SHOWN ON THIS DRAWING ARE ONLY PPROXIMATE. NO GUARANTEE IS EITHER EXPRESSED OR MPLIED AS TO THE COMPLETENESS OR ACCURACY THEREOF THE CONTRACTOR SHALL BE EXCLUSIVELY RESPONSIBLE FO PRIOR TO THE START OF CONSTRUCTION.

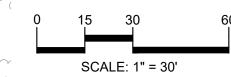

CLIENT **CUNNINGHAM** LIMP COMPANY 28970 CABOT DR, STE. 100

PROJECT TITLE **FARMINGTON** 12 MILE ROAD & INVESTMENT DRIVE FARMINGTON HILLS, OAKLAND COUNTY, MI

> REVISIONS ENGINEERING SUBMITTAL II 05-02-25 SIDEWALK/DUMPSTER SKETCH 05-30-25 SITE PLAN RESUBMITTAL 06-06-25

> > ORIGINAL ISSUE DATE: FEBRUARY 21, 2025

DRAWING TITLE **GENERAL UTILITY PLAN**

PEA JOB NO. 24-0991 DRAWING NUMBER:


PAVING NOTES:

- IN AREAS WHERE NEW PAVEMENTS ARE BEING CONSTRUCTED, THE TOPSOIL AND SOIL CONTAINING ORGANIC MATTER SHALL BE REMOVED PRIOR TO PAVEMENT CONSTRUCTION.
- REFER TO ARCHITECTURAL PLANS FOR DETAILS OF FROST SLAB AT EXTERIOR BUILDING DOORS.
- CONSTRUCTION TRAFFIC SHOULD BE MINIMIZED ON THE NEW PAVEMENT. IF CONSTRUCTION TRAFFIC IS ANTICIPATED ON THE PAVEMENT STRUCTURE, THE INITIAL LIFT THICKNESS COULD BE INCREASED AND PLACEMENT OF THE FINAL LIFT COULD BE DELAYED UNTIL THE MAJORITY OF THE CONSTRUCTION ACTIVITIES HAVE BEEN COMPLETED. THIS ACTION WILL ALLOW REPAIR OF LOCALIZED FAILURE, IF ANY DOES OCCUR, AS WELL AS REDUCE LOAD DAMAGE ON THE
- . ALL EXPANSION JOINTS AND CONCRETE PAVEMENT JOINTS TO BE SEALED.
- CONCRETE PAVEMENT JOINTING UNLESS SHOWN OTHERWISE IN THE PLANS OR REQUIRED BY THE AUTHORITY HAVING JURISDICTION; 5.1. WHERE PROPOSED CONCRETE ABUTS A STRUCTURE, PROVIDE A MINIMUM 1/2" EXPANSION JOINT. THE JOINT FILLER BOARD MUST BE AT LEAST THE FULL DEPTH OF THE CONCRETE
- AND HELD DOWN A 1/2" TO ALLOW FOR SEALING. 5.2. WHERE PROPOSED CONCRETE ABUTS EXISTING CONCRETE OR IN BETWEEN POURS OF PROPOSED CONCRETE (CONSTRUCTION JOINT), PROVIDE 5/8" DOWELS EVERY 30" CENTER TO CENTER HALF WAY ALONG THE THICKNESS OF THE PROPOSED PAVEMENT. ALTERNATE DOWELS SIZES AND SPACING MUST BE APPROVED THE ENGINEER PRIOR TO COMMENCING
- WORK AND VIA THE SUBMITTAL PROCESS. 5.3. WHERE PROPOSED CONCRETE ABUTS EXISTING OR PROPOSED SIDEWALK OR CURBING,
- PROVIDE A MINIMUM 1/2" EXPANSION JOINT. 5.4. CONTROL, LONGITUDINAL AND/OR TRANSVERSE JOINTS SHALL BE PLACED TO PROVIDE PANELS WITHIN THE PAVEMENT AS SQUARE AS POSSIBLE WITH THE FOLLOWING MAXIMUM SPACING PARAMETERS:
- 5.4.1. 6-INCH THICK CONCRETE PAVEMENT: 12' X 12' 5.4.2. 8-INCH THICK CONCRETE PAVEMENT: 15' X 15'
- 5.5. IRREGULAR—SHAPED PANELS MAY REQUIRE THE USE OF REINFORCING MESH OR FIBER MESH AS DETERMINED BY THE ENGINEER. THE USE OF MESH MUST BE APPROVED THE ENGINEER PRIOR TO COMMENCING WORK AND VIA THE SUBMITTAL PROCESS.
- 5.6. IF A JOINT PLAN IS NOT PROVIDED IN THE PLANS, THE CONTRACTOR SHALL SUBMIT ONE TO THE ENGINEER FOR REVIEW PRIOR TO COMMENCING WORK AND VIA THE SUBMITTAL
- CONCRETE CURBING JOINTING UNLESS SHOWN OTHERWISE IN THE PLANS OR REQUIRED BY THE AUTHORITY HAVING JURISDICTION
- 6.1. JOINTS WHEN ADJACENT TO ASPHALT PAVEMENT 6.1.1. PLACE CONTRACTION JOINTS AT 10' INTERVALS
- 6.1.2. PLACE 1/2" EXPANSION JOINT AT CATCH BASINS, EXISTING AND PROPOSED SIDEWALK 6.1.3. PLACE 1" EXPANSION JOINT:
- 6.1.3.1. AT SPRING POINTS OF INTERSECTIONS OR ONE OF THE END OF RADIUS LOCATIONS
- 6.1.3.2. AT 400' MAXIMUM INTERVALS ON STRAIGHT RUNS 6.1.3.3. AT THE END OF RADIUS AT OPPOSITE ENDS IN A CURBED LANDSCAPE ISLAND
- 6.2. JOINTS WHEN TIED TO CONCRETE PAVEMENT 6.2.1. PLACE CONTRACTION JOINTS OPPOSITE ALL TRANSVERSE CONTRACTION JOINTS IN
- 6.2.2. PLACE 1/2" EXPANSION JOINT AT CATCH BASINS, EXISTING AND PROPOSED SIDEWALK OR EXISTING CURBING.
- 6.2.3. PLACE 1"EXPANSION JOINT OPPOSITE ALL TRANSVERSE EXPANSION JOINTS IN
- PAVEMENT 6.2.4. CURB AND GUTTER AND CONCRETE SHALL BE TIED TOGETHER SIMILAR TO A
- LONGITUDINAL LANE TIE JOINT (MDOT B1 JOINT) 6.3. IN BETWEEN POURS OF PROPOSED CONCRETE CURBING (CONSTRUCTION JOINT):
- 6.3.1. CARRY THE REBAR CONTINUOUSLY BETWEEN POURS 6.3.2. IF THE REBAR IS NOT LONG ENOUGH TO CARRY CONTINUOUSLY, THEN TIE TWO PIECES OF REBAR PER THE LATEST MDOT SPECIFICATIONS
- CONCRETE SIDEWALK JOINTING UNLESS SHOWN OTHERWISE IN THE PLANS OR REQUIRED BY THE AUTHORITY HAVING JURISDICTION 7.1. PLACE TRANSVERSE CONTRACTION JOINTS EQUAL TO THE WIDTH OF THE WALK WHEN WIDTH
- IS LESS THAN 8' 7.2. PLACE TRANSVERSE AND LONGITUDINAL CONTRACTION JOINTS EQUAL TO 1/2 THE WIDTH OF
- THE WALK WHEN WIDTH IS EQUAL TO OR GREATER THAN 8' 7.3. PLACE 1" EXPANSION JOINT WHERE ABUTTING SIDEWALK RAMP AND/OR RADIUS IN
- 7.4. PLACE TRANSVERSE 1/2" EXPANSION JOINT AT MAXIMUM OF 100' SPACING
- 7.5. PLACE 1/2" EXPANSION JOINT WHEN ABUTTING A FIXED STRUCTURE, OTHER PAVEMENT (CONCRETE PAVEMENT AND DRIVE APPROACHES), UTILITY STRUCTURES, LIGHT POLE BASES


CONSTRUCTION MATERIAL SUBMITTALS


UNLESS REQUIRED OTHERWISE IN THE PROJECT SPECIFICATIONS, THE CONTRACTOR SHALL ONLY REVIEW BY THE ENGINEER. UNLESS APPROVED IN ADVANCE AND IN WRITING BY THE ENGINEER. ANY MATERIAL SUBMITTALS PROVIDED TO THE ENGINEER FOR REVIEW IN ADDITION TO THIS LIST SHALL BE RETURNED TO THE CONTRACTOR WITHOUT A REVIEW BEING PERFORMED.


- SOIL EROSION AND SEDIMENTATION CONTROL MEASURES
- UTILITY TRENCH BACKFILL MATERIAL WITH ALL MATERIAL DATA INCLUDED IN THE SUBMITTAL BEING DATED WITHIN 60 DAYS OF THE SUBMITTAL UNLESS APPROVED OTHERWISE BY THE
- RIP RAP MATERIAL WITH ALL MATERIAL DATA INCLUDED IN THE SUBMITTAL BEING DATED WITHIN 60 DAYS OF THE SUBMITTAL UNLESS APPROVED OTHERWISE BY THE ENGINEER
- STORM AND SANITARY SEWER PIPING INCLUDING JOINTS
- 5. STORM AND SANITARY SEWER STRUCTURES
- STORM AND SANITARY SEWER STRUCTURE FRAME AND COVERS INCLUDING CLEAN OUTS
- WATER DISTRIBUTION SYSTEM PIPING INCLUDING JOINTS
- B. WATER DISTRIBUTION SYSTEM STRUCTURES
- . WATER DISTRIBUTION SYSTEM STRUCTURE FRAME AND COVERS
- 10. WATER DISTRIBUTION SYSTEM SHUT OFF BOXES
- 1. WATER DISTRIBUTION SYSTEM FIRE HYDRANTS
- 12. WATER DISTRIBUTION SYSTEM GATE VALVES
- 13. STORM WATER MANAGEMENT OUTLET CONTROL STRUCTURES INCLUDING COVERS OR GRATES
- 14. STORM WATER MANAGEMENT MECHANICAL PRE-TREATMENT UNITS INCLUDING COVERS
- 5. STORM WATER MANAGEMENT UNDERGROUND DETENTION SYSTEM MATERIAL AND SHOP DRAWINGS DEPICTING THE LAYOUT OF THE SYSTEM
- 16. PAVEMENT AGGREGATE BASE MATERIAL WITH ALL MATERIAL DATA INCLUDED IN THE SUBMITTAL BEING DATED WITHIN 60 DAYS OF THE SUBMITTAL UNLESS APPROVED OTHERWISE BY THE
- 7. PAVEMENT UNDERDRAIN MATERIAL AND BACKFILL WITH ALL BACKFILL MATERIAL DATA INCLUDED IN THE SUBMITTAL BEING DATED WITHIN 60 DAYS OF THE SUBMITTAL UNLESS APPROVED OTHERWISE BY THE ENGINEER
- 18. PAVEMENT MIX DESIGNS SUBMITTED FOR REVIEW BY THE ENGINEER MUST FOLLOW THE CURRENT MDOT REVIEW CHECKLISTS AS SUMMARIZED BELOW AND ALL MATERIAL DATA INCLUDED IN THE SUBMITTAL BEING DATED WITHIN 60 DAYS OF THE SUBMITTAL UNLESS APPROVED OTHERWISE B'
- •8.1. CONCRETE MIX DESIGN REVIEW CHECKLIST (FORM 2000) •8.2. SUPERPAVE MIX DESIGN CHECKLIST (FORM 1862)
- •8.3. MARSHALL MIX DESIGN CHECKLIST (FORM 1849)
- 19. SITE FENCING AND GATES INCLUDING FOOTINGS
- 20. ANY ITEMS SHOWN IN THE PLANS OR DETAIL SHEETS THAT SPECIFICALLY STATE FOR THE CONTRACTOR TO SUBMIT A SHOP DRAWING TO THE ENGINEER FOR REVIEW. THESE ITEMS INCLUDE, BUT ARE NOT LIMITED TO:
- •• RETAINING WALL MATERIAL AND STRUCTURAL CALCULATIONS
- ANY SPECIALITY ITEMS SHOWN IN THE PLANS OR DETAIL SHEETS THAT SPECIFICALLY DO NOT STATE FOR THE CONTRACTOR SHALL SUBMIT A SHOP DRAWING TO THE ENGINEER FOR REVIEW BUT THE CONTRACTOR REQUESTS TO BE REVIEWED. THE CONTRACTOR'S REQUEST FOR REVIEW MUST BE IN WRITING AND APPROVED BY THE ENGINEER PRIOR TO SUBMITTING

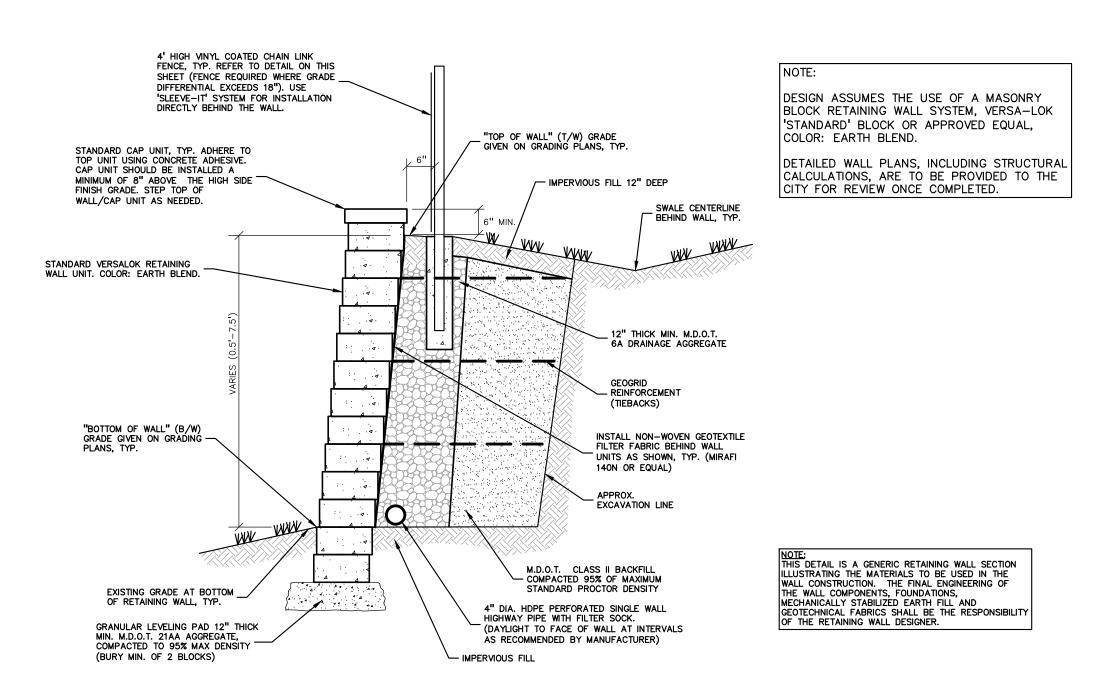


SECTION THROUGH RETAINING WALL

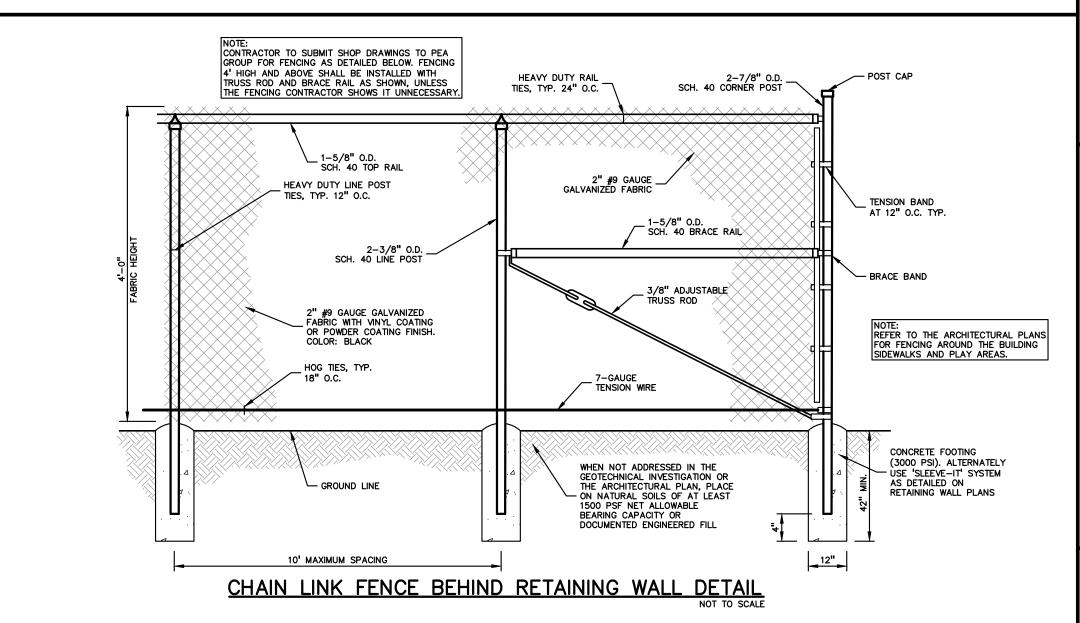

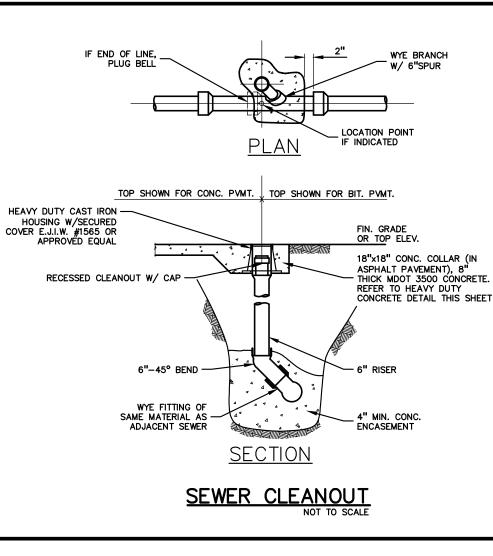

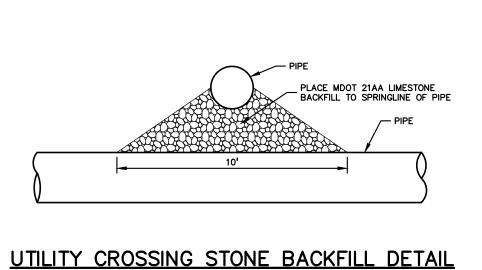


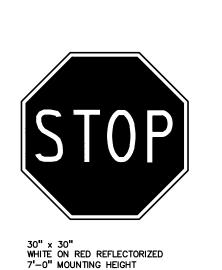



STOP SIGN DETAIL






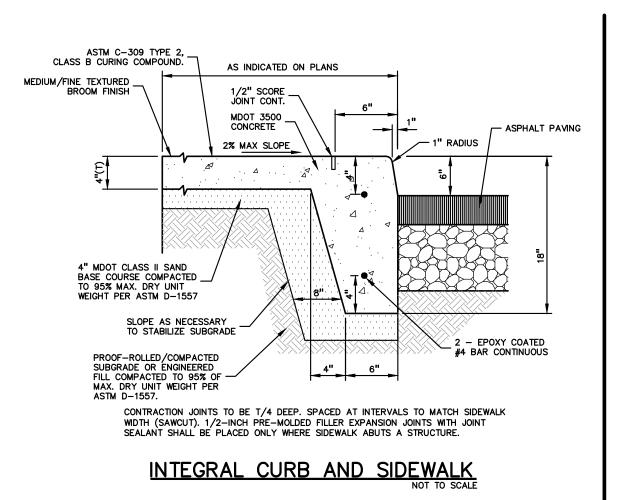


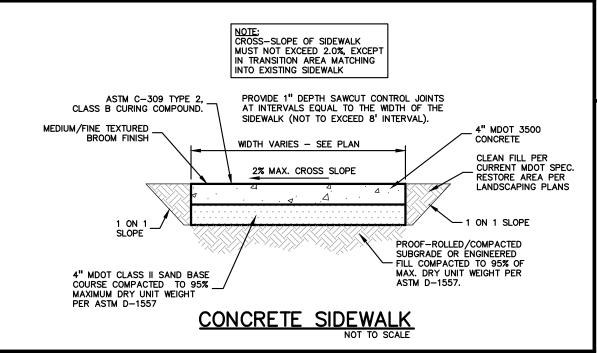

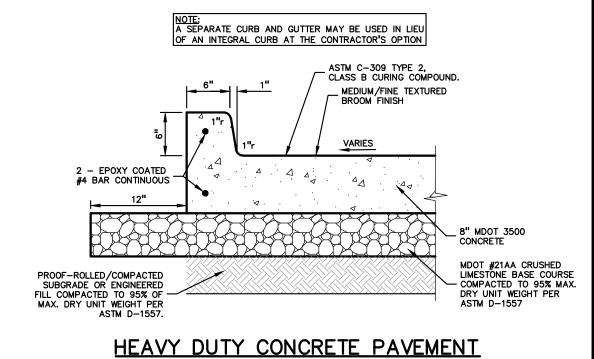

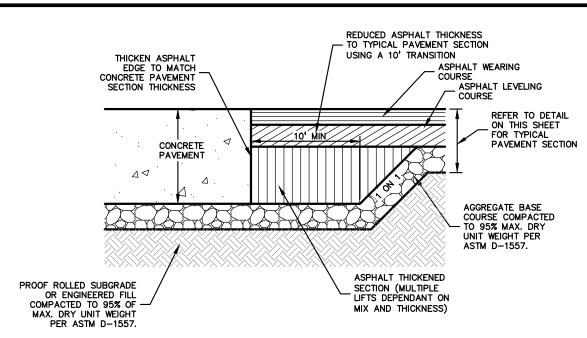


THICKENED EDGE ASPHALT DETAIL

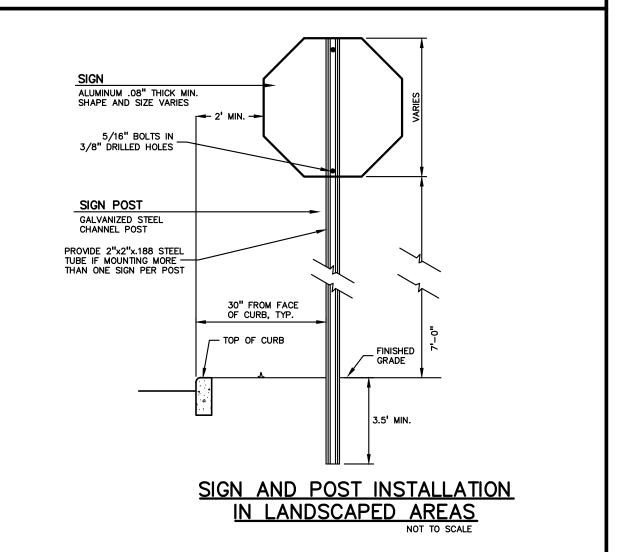

AGGREGATE BASE NOTE:
THIS PAVEMENT SECTION DESIGN ASSUMES THE USE OF MDOT 21AA CRUSHED
LIMESTONE BASE MATERIAL THAT MEETS THE REQUIREMENTS OF MDOT STANDARD
SPECIFICATION SECTION 902 FOR AGGREGATES. IF CRUSHED CONCRETE AGGREGATE
BASE IS PROPOSED IN LIEU OF THE SPECIFIED CRUSHED LIMESTONE MATERIAL, PEA GROUP WILL REQUIRE A MINIMUM 25% INCREASE IN BASE THICKNESS. HOWEVER, IF TESTING DOCUMENTATION IS PROVIDED TO PEA GROUP THAT SHOWS THAT THE CRUSHED CONCRETE MATERIAL MEETS ALL REQUIREMENTS OF MDOT SPECIFICATION SECTION 902, THEN THE 25% INCREASE IN THICKNESS MAY BE REEVALUATED.


ASPHALT MATERIAL NOTES:
HOT-MIX ASPHALT MIXTURES UTILIZING RECYCLED ASPHALT PAVEMENT (RAP) MUST
MEET MDOT SPECIAL PROVISION 12SP501(E). THE BINDER GRADE FOR THIS WORK IS
PG64-28. IF ASPHALT MIXES CONTAINING RAP ARE TO BE SUPPLIED FOR THIS PROJECT. THE ASPHALT BINDER MUST BE REVISED PER MDOT 'TIER 1' OR 'TIER 2' REQUIREMENTS (RAP CONTENT UP TO 27% MAXIMUM). TIER 3 MIXES ARE NOT ACCEPTABLE ON THIS PROJECT. AN ASPHALT MIX DESIGN FOR ALL SPECIFIED MIXES SHOULD BE FORWARDED TO PEA GROUP FOR REVIEW PRIOR TO CONSTRUCTION

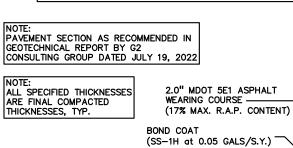


2.0" MDOT 4E1 ASPHALT LEVELING COURSE ——— (27% MAX. R.A.P. CONTENT) 8" MDOT 21AA CRUSHED LIMESTONE BASE COURSE COMPACTED TO 95% MAX. DRY UNIT WEIGHT PER ASTM D-1557 PROOF—ROLLED/COMPACTED SUBGRADE OR ENGINEERED FILL COMPACTED TO 95% OF -MAX. DRY UNIT WEIGHT PER ASTM D-1557.


STANDARD DUTY ASPHALT DETAIL (NOT FOR USE IN THE RIGHT-OF-WAY)

A SEPARATE CURB AND GUTTER MAY BE USED IN LIEU OF AN INTEGRAL CURB AT THE CONTRACTOR'S OPTION

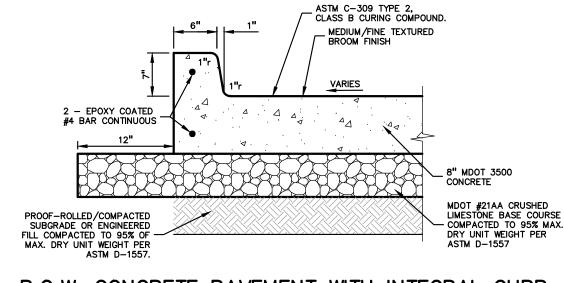


R.O.W. CONCRETE PAVEMENT WITH INTEGRAL CURB

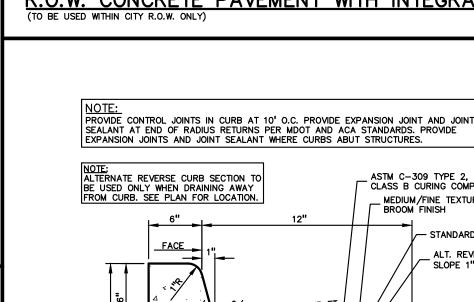

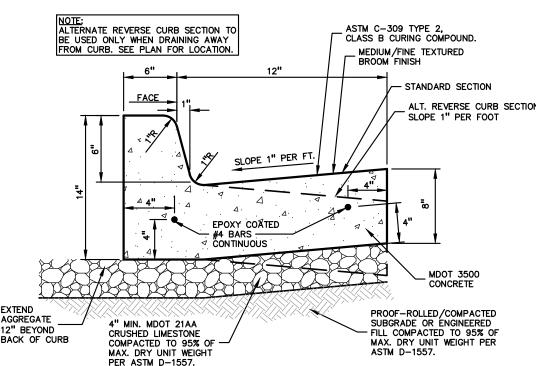

18"x6" STANDARD CONCRETE CURB AND GUTTER

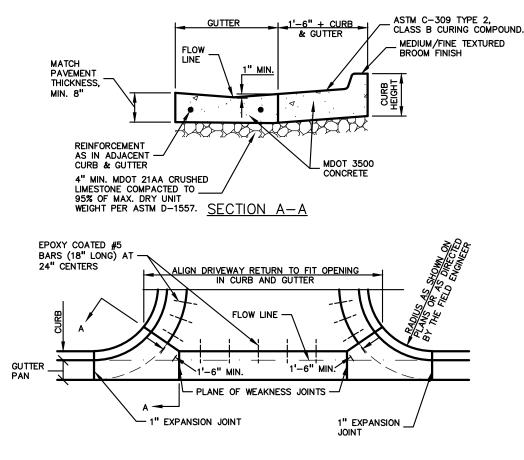


MDOT DRIVEWAY OPENING-DETAIL 'M'

HOUSER License N 6201046876

t: 844.813.2949

www.peagroup.com

CAUTION!! THE LOCATIONS AND ELEV JTILITIES AS SHOWN ON THIS DRAWING ARE ONLY PPROXIMATE. NO GUARANTEE IS EITHER EXPRESSED OR DETERMINING THE EXACT UTILITY LOCATIONS AND ELEVATIONS PRIOR TO THE START OF CONSTRUCTION.

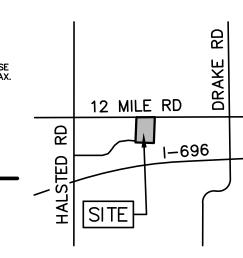

CLIENT

CUNNINGHAM 28970 CABOT DR, STE. 100

PROJECT TITLE

FARMINGTON 12 MILE ROAD & INVESTMENT DRIVE FARMINGTON HILLS, OAKLAND COUNTY, MI

REVISIONS ENGINEERING SUBMITTAL II 05-02-25 SIDEWALK/DUMPSTER SKETCH 05-30-25 SITE PLAN RESUBMITTAL ORIGINAL ISSUE DATE: FEBRUARY 21, 2025 DRAWING TITLE

NOTES AND DETAILS

PEA JOB NO. 24-0991 JRH DN. PB DES. DRAWING NUMBER:


GENERAL ADA ACCESSIBILITY NOTES:


THE FOLLOWING NOTES PROVIDE AN OUTLINE OF SOME OF THE REQUIREMENTS CONTAINED WITHIN THE "STANDARDS FOR ACCESSIBLE DESIGN - AMERICANS WITH DISABILITIES ACT 2010", AND "ACCESSIBLE AND USEABLE BUILDINGS AND FACILITIES", ICC/ANSI A117.1-2009. THE CONTRACTOR IS RESPONSIBLE FOR ALL OF THE REQUIREMENTS PRESENTED WITHIN THESE DOCUMENTS, WHICH ARE AVAILABLE IN FULL UPON REQUEST.

- 1. THE RUNNING SLOPE OF ALL WALKING SURFACES SHALL NOT EXCEED 5% (1:20) AND THE CROSS-SLOPE SHALL NOT
- EXCEED 2% (1:48) 2. WALKING SURFACES MUST BE LEVEL WITH PERMITTED VERTICAL CHANGES IN LEVEL NOT TO EXCEED 1/4", OR BEVELED CHANGES IN LEVEL NOT TO EXCEED 1/2". REFER TO DETAIL DET-8 THIS SHEET. ANY CHANGE IN LEVEL GREATER THAN
- 3. TURNING SPACES ALONG ACCESSIBLE ROUTES MUST BE AT LEAST 5 FEET WIDE IN ALL DIRECTIONS AND NOT EXCEED 2% SLOPE (1:48) IN ANY DIRECTION.
- 4. ACCESSÌBLE ROUTES WILL BE DESIGNED TO BE A MINIMUM OF 5 FEET WIDE. THE MINIMUM CLEAR WIDTH IS 3 FEET. 5. RAMPS ALONG ACCESSIBLE ROUTES WILL HAVE A RUNNING SLOPE GREATER THAN 5% (1:20) AND LESS THAN 8.3% (1:12).
- 6. THE CROSS-SLOPE OF RAMP RUNS SHALL NOT EXCEED 2% (1:48) 7. THE MINIMUM CLEAR WIDTH OF ANY RAMP IS 36 INCHES.
- 8. THE MAXIMUM RISE FOR ANY RAMP (NOT INCLUDING CURB RAMPS) SHALL NOT EXCEED 30 INCHES. LANDINGS ARE REQUIRED AT THE TOP AND BOTTOM OF EACH RAMP. LANDINGS SHALL HAVE A CROSS-SLOPE NOT EXCEEDING 2% (1:48), SHALL BE 5 FEET LONG AND AT LEAST AS WIDE AS THE RAMP CLEAR WIDTH. IF THERE IS A CHANGE OF DIRECTION AT A LANDING, THEN THE LANDING MUST BE AT LEAST 5 FEET WIDE AND 5 FEET LONG.
- 9. HANDRAILS ARE REQUIRED FOR ANY RAMP (NOT INCLUDING CURB RAMPS) WITH A RISE GREATER THAN 6 INCHES. ALL HANDRAILS ARE REQUIRED TO HAVE EDGE PROTECTION UNLESS ADJOINING ANOTHER ACCESS POINT OR IF THE VERTICAL DROP-OFF AT THE EDGE OF THE RAMP DOES NOT EXCEED 1/2" IN 10 FEET. EDGE PROTECTION CAN BE PROVIDED BY MEANS OF A 4" MIN. CURB OR BARRIER.
- 10. CURB RAMPS ALONG ACCESSIBLE ROUTES SHALL NOT BE STEEPER THAN 8.3% (1:12). APPROACHING SLOPES TO THE RAMP CANNOT EXCEED 5%, WHICH INCLUDES SIDEWALKS, PAVEMENT, GUTTERS ETC.
- 11. IF CURB RAMP SIDES ARE FLARED, THE FLARES SHALL NOT BE STEEPER THAN 10% (1:10)
- 12. CURB RAMPS SHALL BE LOCATED OR PROTECTED TO PREVENT THEIR OBSTRUCTION BY PARKED VEHICLES. 13. HANDRAILS ARE NOT REQUIRED ON CURB RAMPS. 14. WHERE DETECTABLE WARNING IS REQUIRED AT CURB RAMPS, THE DETECTABLE WARNING SHALL BE 24" MINIMUM IN DEPTH
- AND SHALL EXTEND THE FULL WIDTH OF THE RAMP. THE DETECTABLE WARNING SHALL BE LOCATED SO THE EDGE NEAREST THE CURB IS 6 INCHES MINIMUM AND 8 INCHES MAXIMUM FROM THE CURB LINE. 15. ACCESSIBLE PARKING SPACES ON SITE SHALL BE PROVIDED AS REQUIRED IN SECTION 502 OF THE ADA IF THE SITE HAS MORE THAN ONE PARKING FACILITY, EACH FACILITY IS REQUIRED TO MEET THESE REQUIREMENTS SEPARATELY. THE
- REQUIRED NUMBER OF SPACES SHALL BE BASED ON THE TOTAL NUMBER OF PARKING SPACES IN EACH PARKING FACILITY 16. FOR EVERY SIX OR FRACTION OF SIX ACCESSIBLE PARKING SPACES, ONE VAN ACCESSIBLE SPACE SHALL BE PROVIDED. 17. ACCESSIBLE PARKING SPACES SHALL BE LOCATED ON THE SHORTEST ACCESSIBLE ROUTE FROM PARKING TO A BUILDING ENTRANCE. IF THERE IS MORE THAN ONE ACCESSIBLE ENTRANCE, PARKING SHALL BE DISPERSED ALONG THE SHORTEST
- ACCESSIBLE ROUTE TO THE ACCESSIBLE ENTRANCES. 18. ADA ACCESSIBLE CAR PARKING SPACES SHALL BE A MINIMUM OF 8 FEET WIDE WITH AN ACCESS AISLE 5 FEET WIDE MINIMUM. VAN ACCESSIBLE PARKING SPACES SHALL BE AT LEAST 11 FEET WIDE WITH A 5' WIDE ACCESS AISLE. VAN ACCESSIBLE SPACES ARE ALSO ACCEPTABLE WITH AN 8 FOOT WIDTH AND 8 FOOT WIDE ACCESS AISLE. THE ACCESS AISLE IN ALL CASES MUST EXTEND THE FULL LENGTH OF THE PARKING SPACE.
- 19. SURFACE SLOPES WITHIN THE PARKING SPACES AND AISLES SHALL NOT EXCEED 2% (1:48) 20. ACCESSIBLE AREAS INCLUDING PARKING SPACES, AISLES AND PATHWAYS, REQUIRE A MINIMUM VERTICAL CLEARANCE OF
- 21. ACCESSIBLE PARKING SPACES ARE REQUIRED TO BE IDENTIFIED BY SIGNS. THE SIGNS SHALL INCLUDE THE INTERNATIONAL SYMBOL OF ACCESSIBILITY. VAN PARKING SPACES ARE REQUIRED TO BE DESIGNATED AS "VAN ACCESSIBLE". REFER TO DETAILS ON THIS SHEET.


RAMP NOTES

- 1. SURFACE TEXTURE OF THE RAMP SHALL BE THAT OBTAINED BY A COARSE BROOMING, TRANSVERSE TO THE RUNNING SLOPE.
- 2. SIDEWALK SHALL BE RAMPED WHERE THE DRIVEWAY CURB IS EXTENDED ACROSS THE WALK.
- 3. CARE SHALL BE TAKEN TO ASSURE A UNIFORM GRADE ON THE RAMP. WHERE CONDITIONS PERMIT, IT IS DESIRABLE THAT THE SLOPE OF THE RAMP BE IN ONLY ONE DIRECTION, PARALLEL TO THE DIRECTION OF TRAVEL.
- 4. RAMP WIDTH SHALL BE INCREASED, IF NECESSARY, TO ACCOMMODATE SIDEWALK SNOW REMOVAL EQUIPMENT NORMALLY USED BY THE MUNICIPALITY.
- 5. WHEN 5' MINIMUM WIDTHS ARE NOT PRACTICABLE, RAMP WIDTH MAY BE REDUCED TO NOT LESS THAN 4' AND LANDINGS TO NOT LESS THAN 4' X 4'.
- 6. CURB RAMPS WITH A RUNNING SLOPE LESS THAN 5% DO NOT REQUIRE A TOP LANDING. HOWEVER, ANY CONTINUOUS SIDEWALK OR PEDESTRIAN ROUTE CROSSING THROUGH OR INTERSECTING THE CURB RAMP MUST INDEPENDENTLY MAINTAIN A CROSS SLOPE NOT GREATER THAN 2% PERPENDICULAR TO ITS OWN DIRECTION(S) OF TRAVEL.
- 7. DETECTABLE WARNING SURFACE COVERAGE IS 24" MINIMUM IN THE DIRECTION OF RAMP/PATH TRAVEL AND THE FULL WIDTH OF THE RAMP/PATH OPENING EXCLUDING CURBED OR FLARED CURB TRANSITION AREAS. A BORDER OFFSET NOT GREATER THAN 2" MEASURED ALONG THE EDGES OF THE DETECTABLE WARNING IS ALLOWABLE. FOR RADIAL CURB THE OFFSET IS MEASURED FROM THE ENDS OF THE RADIUS.
- 8. FOR NEW ROADWAY CONSTRUCTION. THE RAMP CROSS SLOPE MAY NOT EXCEED 2.0%. FOR ALTERATIONS TO EXISTING ROADWAYS, THE CROSS SLOPE MAY BE TRANSITIONED TO MEET AN EXISTING ROADWAY GRADE. THE CROSS SLOPE TRANSITION SHALL BE APPLIED UNIFORMLY OVER THE FULL LENGTH OF THE RAMP.
- 9. DRAINAGE STRUCTURES SHOULD NOT BE PLACED IN LINE WITH RAMPS. THE LOCATION OF THE RAMP SHOULD TAKE PRECEDENCE OVER THE LOCATION OF THE DRAINAGE STRUCTURE. WHERE EXISTING DRAINAGE STRUCTURES ARE LOCATED IN THE RAMP PATH OF TRAVEL, USE A MANUFACTURER'S ADA COMPLIANT GRATE. OPENINGS SHALL NOT BE GREATER THAN 1/2" ELONGATED OPENINGS SHALL BE PLACED SO THAT THE LONG DIMENSION IS PERPENDICULAR TO THE DOMINANT DIRECTION OF TRAVEL.
- 10. THE TOP OF THE JOINT FILLER FOR ALL RAMP TYPES SHALL BE FLUSH WITH THE ADJACENT
- 11. CROSSWALK AND STOP LINE MARKINGS, IF USED, SHALL BE SO LOCATED AS TO STOP TRAFFIC SHORT OF RAMP CROSSINGS. SPECIFIC DETAILS FOR MARKING APPLICATIONS ARE GIVEN IN THE "MICHIGAN MANUAL ON UNIFORM TRAFFIC CONTROL DEVICES".
- 12. FLARED SIDES WITH A SLOPE OF 10% MAXIMUM, MEASURED ALONG THE ROADSIDE CURB LINE, SHALL BE PROVIDED WHERE AN UNOBSTRUCTED CIRCULATION PATH LATERALLY CROSSES THE CURB RAMP. FLARED SIDES ARE NOT REQUIRED WHERE THE RAMP IS BORDERED BY LANDSCAPING, UNPAVED SURFACE OR PERMANENT FIXED OBJECTS. WHERE THEY ARE NOT REQUIRED, FAIRED SIDES CAN BE CONSIDERED IN ORDER TO AVOID SHARP CURB RETURNS AT
- 13. DETECTABLE WARNING PLATES MUST BE INSTALLED USING FABRICATED OR FIELD CUT UNITS CAST AND/OR ANCHORED IN THE PAVEMENT TO RESIST SHIFTING OR HEAVING.

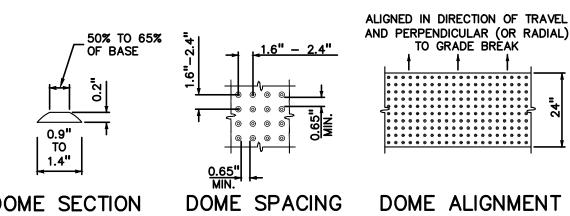


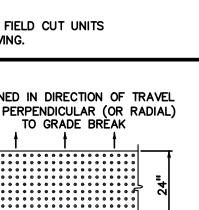

DETECTABLE WARNING DETAILS

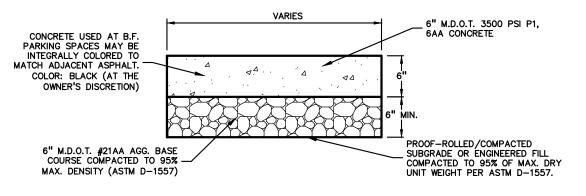



ADA ACCESSIBLE PARKING SPACE ALTERNATE CONCRETE PAVEMENT DETAIL

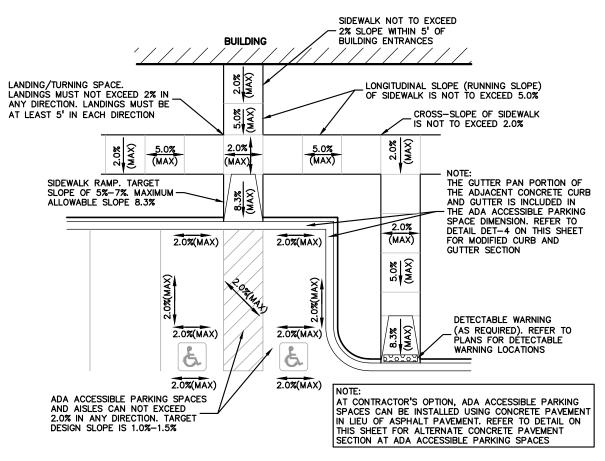


PARKING SPACE GRADING INFORMATION


*MAXIMUM LANDING SLOPE IS 1:48 (2.08%) **MAXIMUM RAMP CROSSING SLOPE IS IN EACH DIRECTION OF TRAVEL. LANDING 1:48 (2.08%). RUNNING SLOPE 5%-7% 1:48 (2.08%). RUNNING SLOPE 5%-7% MINIMUM DIMENSIONS 5' X 5'. SEE NOTES. (8.33% MAXIMUM). SEE NOTES.

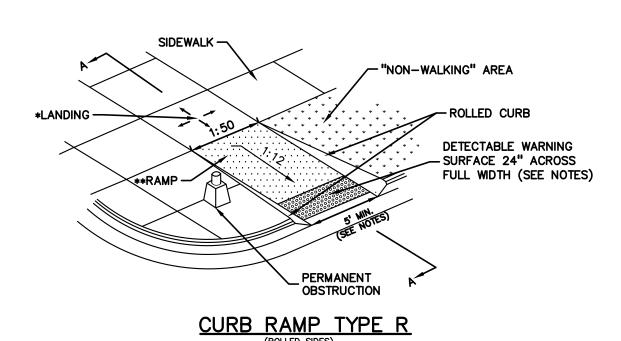

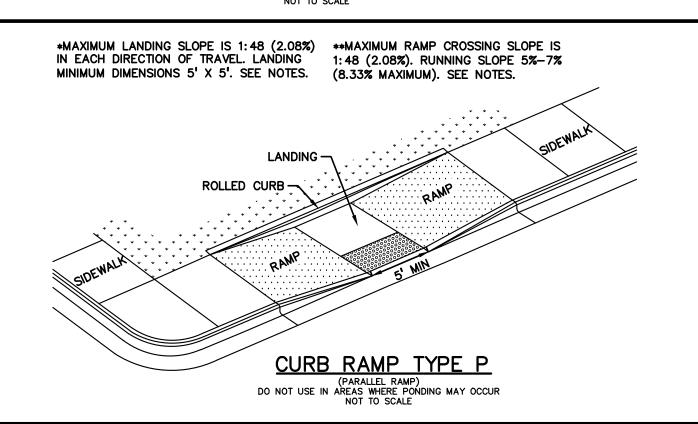


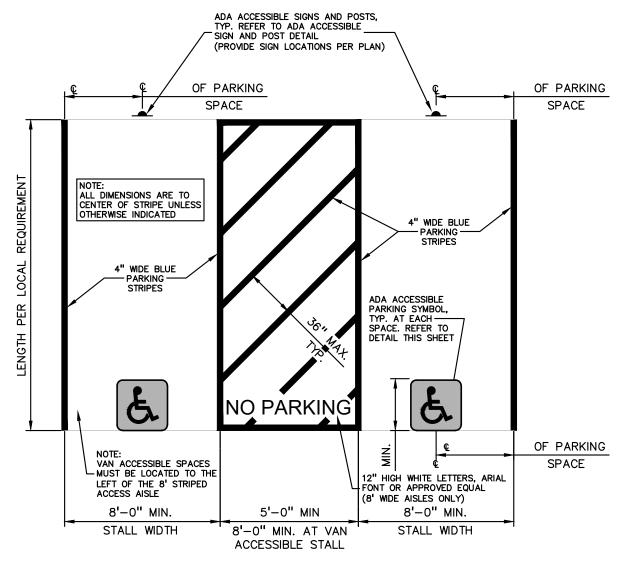

ADA ACCESSIBLE PARKING STALL DETAIL

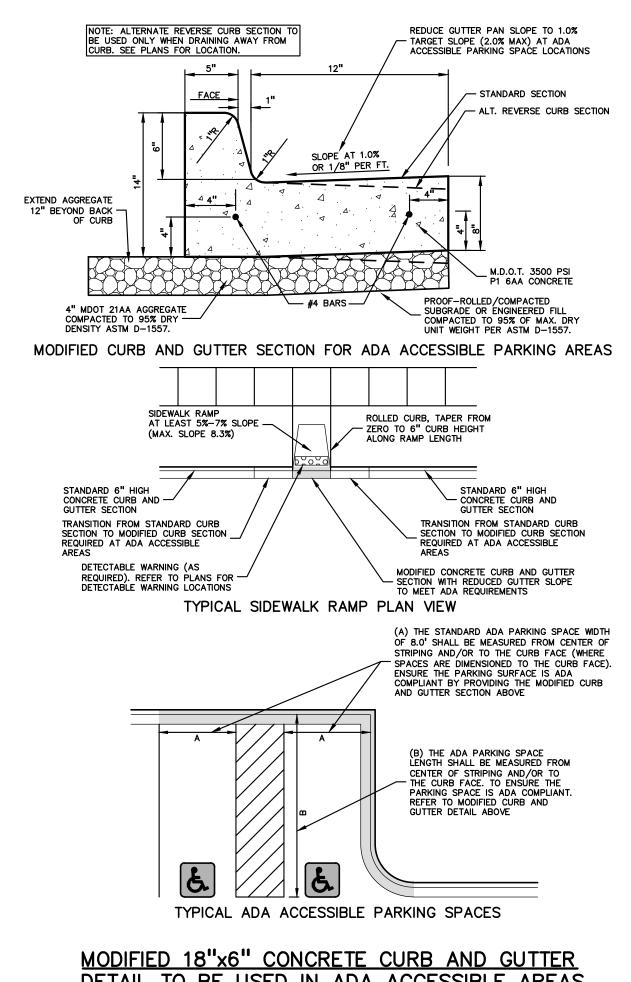

DETAIL TO BE USED IN ADA ACCESSIBLE AREAS

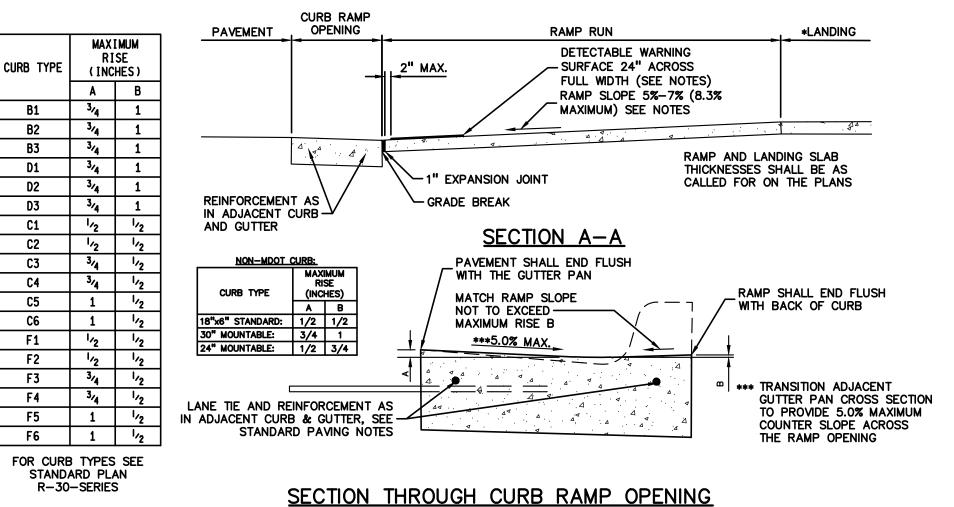


(TYPICAL ALL RAMP TYPES)
NOT TO SCALE

ADA ACCESSIBLE SIGN NOTES:

1. ONE SIGN IS REQUIRED AT EACH ADA ACCESSIBLE PARKING SPACE. 2. ALL SIGNS SHALL COMPLY WITH THE LATEST STANDARDS OF THE MICHIGAN MANUAL OF UNIFORM TRAFFIC CONTROL DEVICES (MMUTCD). 3. WHEN TWO ADA ACCESSIBLE PARKING SPACES ARE ADJACENT AND FACING EACH OTHER, TWO SIGNS ARE REQUIRED, BUT CAN BE MOUNTED ON THE SAME POST. 4. SIGN POSTS SHALL BE 2" NOM. SQUARE 14-GAUGE GALVANIZED STEEL TUBE WITH 7/16" HOLES AT 1" CENTERS. POSTS SHALL TELESCOPE INSIDE ANCHOR POSTS A

5. ANCHOR POSTS SHALL BE 2.25" NOM. SQUARE 12-GAUGE GALVANIZED STEEL POST, A MINIMUM OF 3 FEET LONG. 6. IF THESE NOTES AND DETAILS CONFLICT WITH LOCAL CODES AND ORDINANCES, THE STRICTER REQUIREMENT SHOULD BE USED. 7. ALTERNATE MATERIALS MAY BE USED IF IN COMPLIANCE WITH ADA GUIDELINES AND LOCAL REQUIREMENTS.

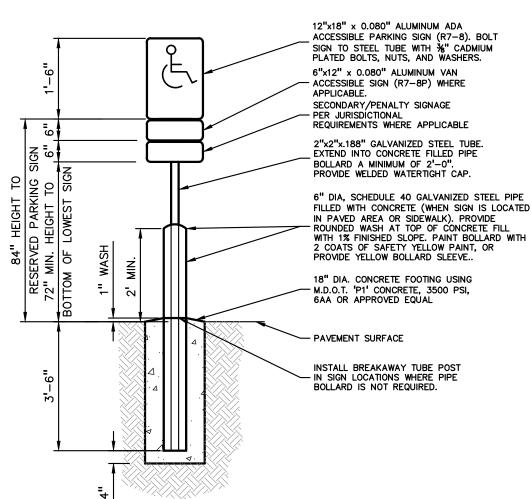



THE LOCATIONS AND ELEVATIONS OF EXISTING UNDERGROUN TILITIES AS SHOWN ON THIS DRAWING ARE ONLY PROXIMATE. NO GUARANTEE IS EITHER EXPRESSED OR

IPLIED AS TO THE COMPLETENESS OR ACCURACY THEREO

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HOUSER


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ADA ACCESSIBLE SIGN AND POST DETAIL








CAUTION!!

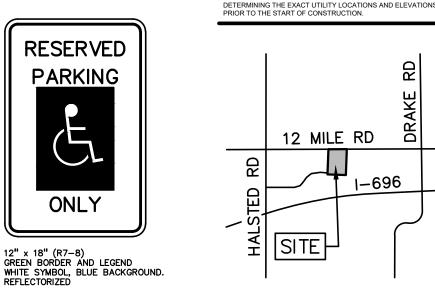CLIENT **CUNNINGHAM** 28970 CABOT DR, STE. 100

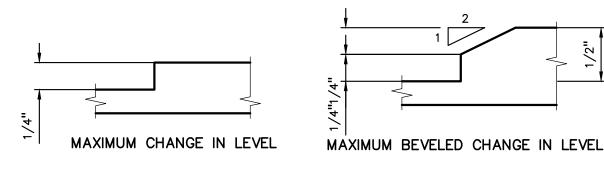

BARRIER FREE SURFACE CHANGE IN LEVEL TOLERANCE PROJECT TITLE **FARMINGTON** 12 MILE ROAD & INVESTMENT DRIVE

REVISIONS

FARMINGTON HILLS, OAKLAND COUNTY, MI

ENGINEERING SUBMITTAL II 05-02-25

SIDEWALK/DUMPSTER SKETCH 05-30-25


SITE PLAN RESUBMITTAL 06-06-25

ORIGINAL ISSUE DATE:

FEBRUARY 21, 2025


DRAWING TITLE

DETAILS

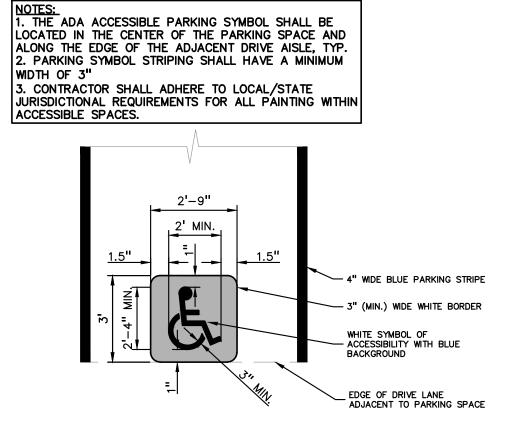

ADA ACCESSIBLE PARKING SYMBOL DETAIL (INTERNATIONAL SYMBOL OF ACCESSIBILITY)


24-0991 PEA JOB NO. P.M. JRH PB DES. PB DRAWING NUMBER:

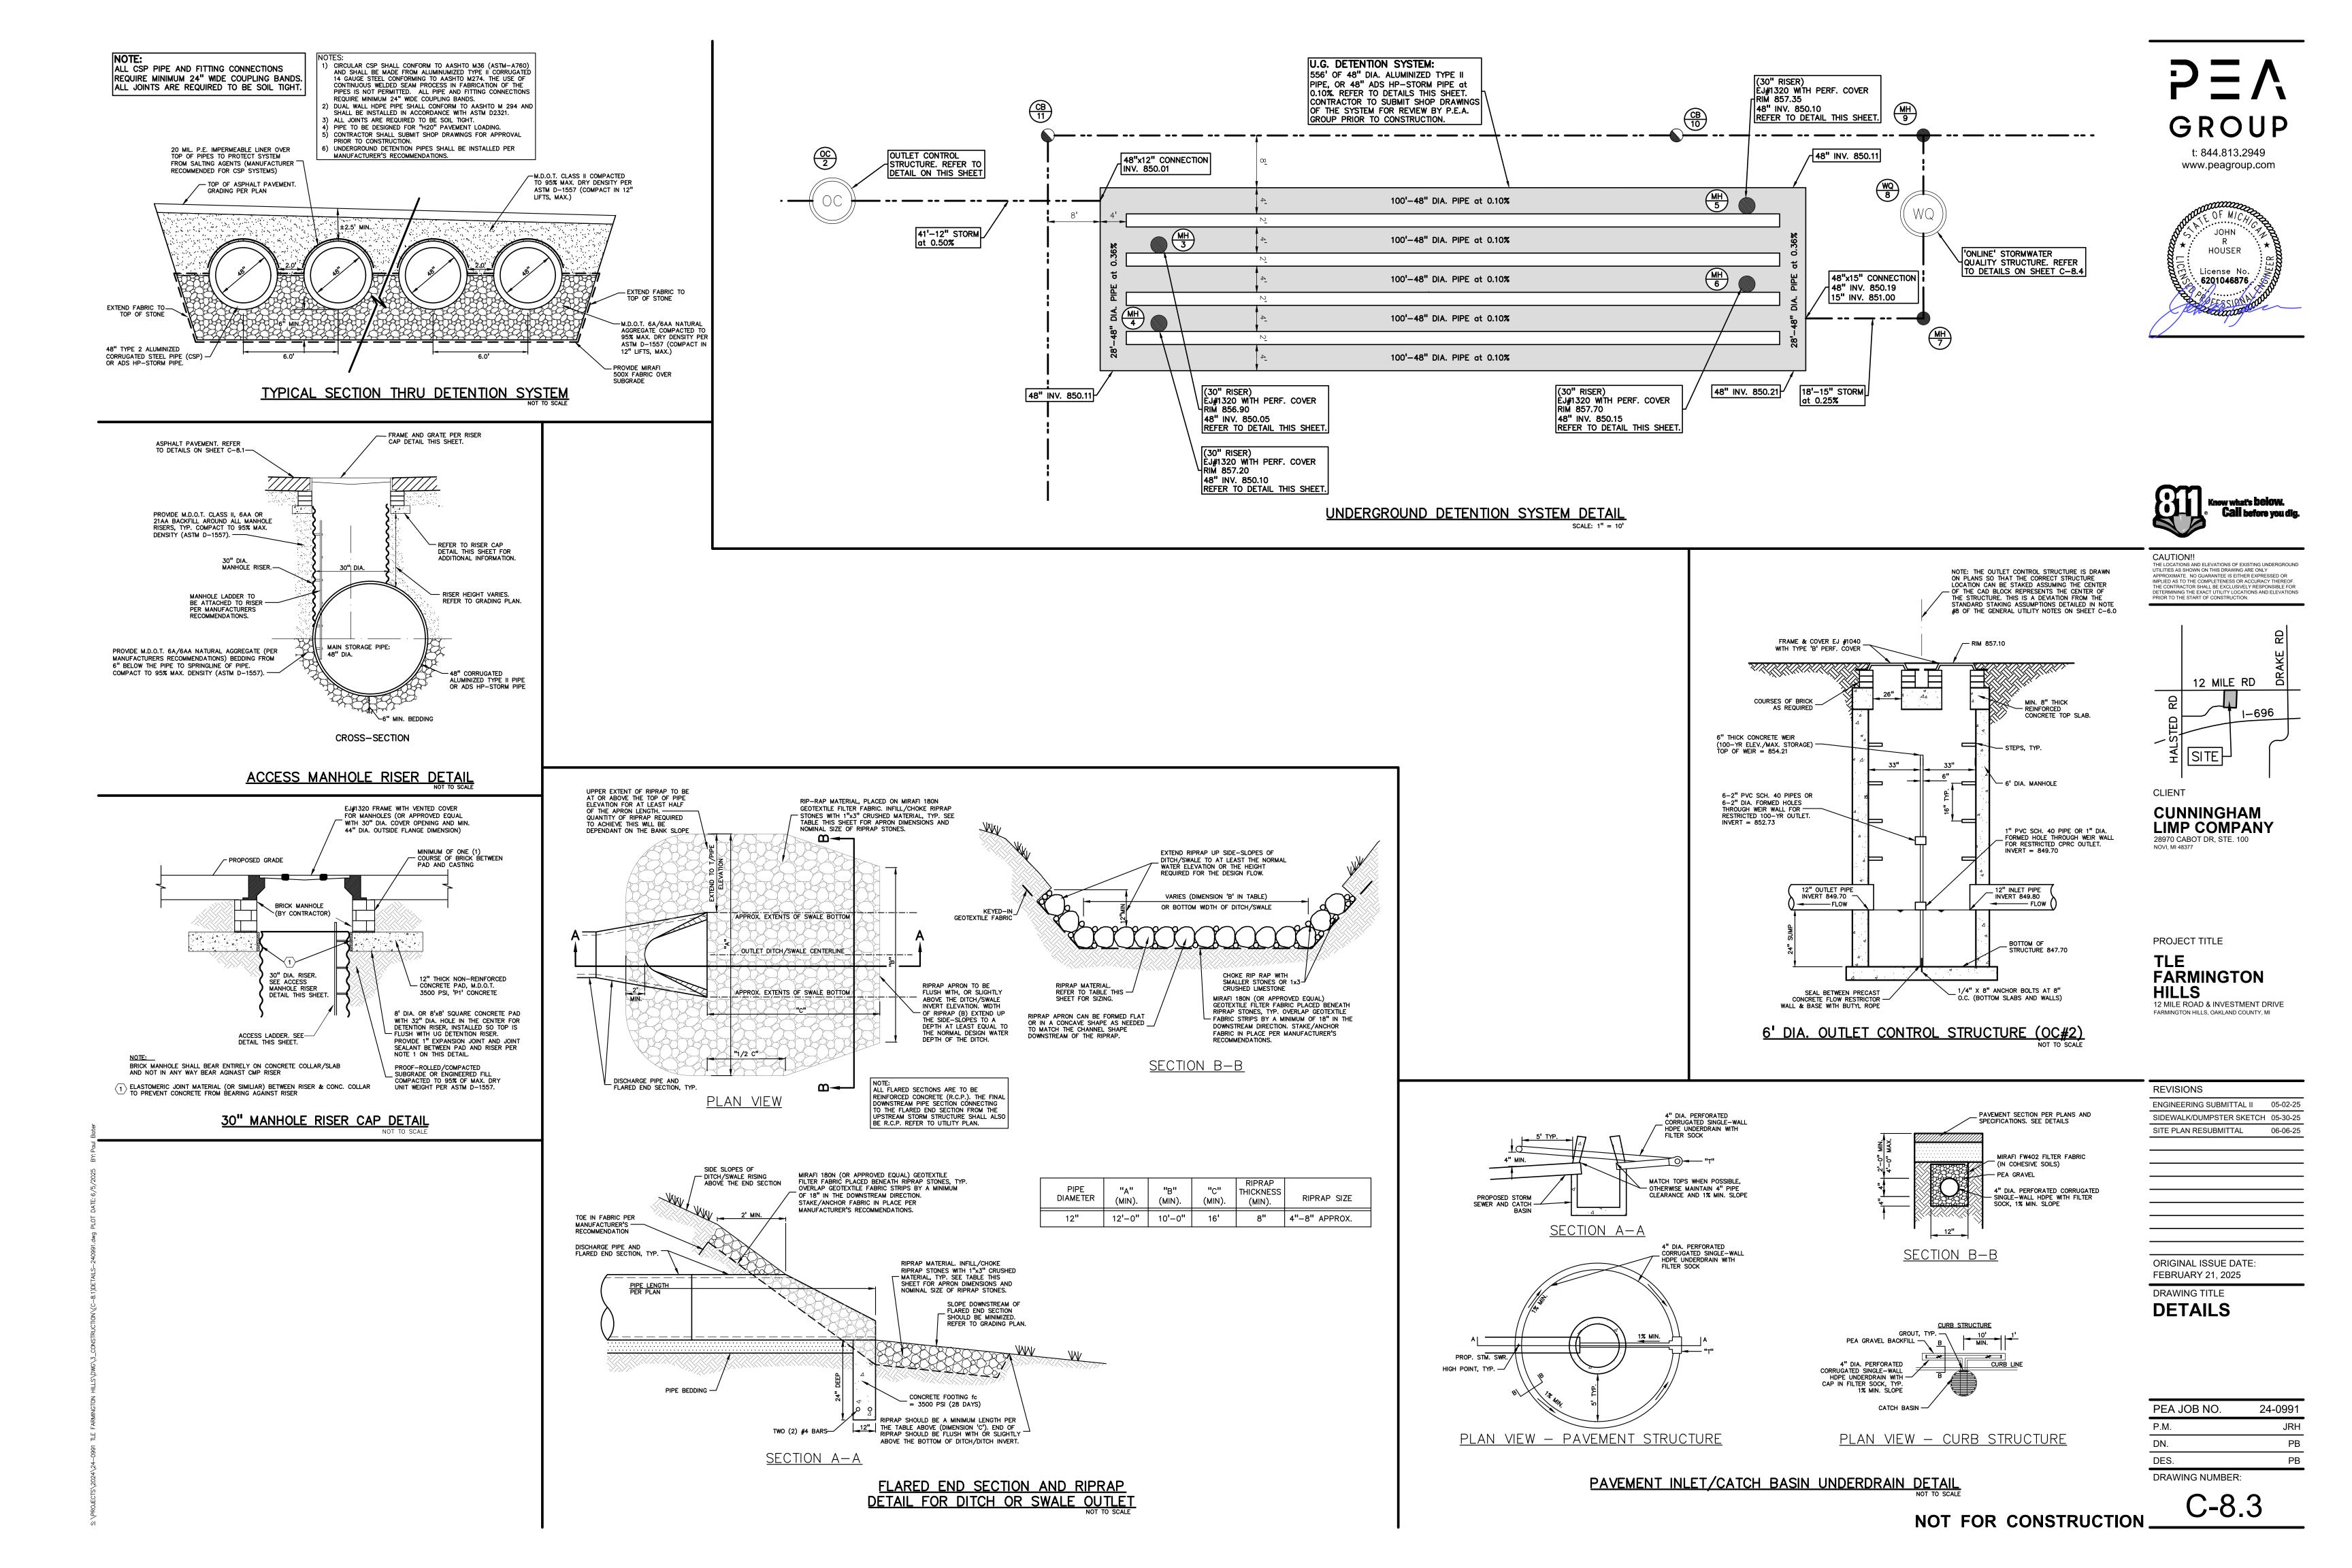

HOUSER 6201046876

CAUTION!! CAU I I UN!!

THE LOCATIONS AND ELEVATIONS OF EXISTING UNDERGROUND UTILITIES AS SHOWN ON THIS DRAWING ARE ONLY
APPROXIMATE. NO GUARANTEE IS EITHER EXPRESSED OR IMPLIED AS TO THE COMPLETENESS OR ACCURACY THEREOF. THE CONTRACTOR SHALL BE EXCLUSIVELY RESPONSIBLE FOR DETERMINING THE EXACT UTILITY LOCATIONS AND ELEVATIONS PRIOR TO THE START OF CONSTRUCTION.

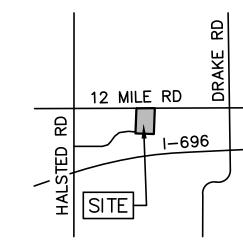

CUNNINGHAM

LIMP COMPANY 28970 CABOT DR, STE. 100 NOVI, MI 48377

PROJECT TITLE TLE
FARMINGTON
HILLS
12 MILE ROAD & INVESTMENT DRIVE
FARMINGTON HILLS, OAKLAND COUNTY, MI

REVISIONS	
ENGINEERING SUBMITTAL II	05-02-25
SIDEWALK/DUMPSTER SKETCH	05-30-25
SITE PLAN RESUBMITTAL	06-06-25

ORIGINAL ISSUE DATE: FEBRUARY 21, 2025

DRAWING TITLE **DETAILS**

PEA JOB NO.	24-0991
P.M.	JRH
DN.	PB
DES.	РВ
DRAWING NUMBER:	

Table A-1 MTFRs and Sediment Removal Intervals for Arcadia Models

Model ¹	Manhole Diameter (ft)	NJDEP 50% TSS Maximum Treatment Flow Rate (cfs)	Treatment Area (ft²)	Hydraulic Loading rate (gpm/ft²)	50% Maximum Sediment Storage ² (ft ³)	Sediment Removal Interval ¹ (months)
Arcadia ARC3	3	0.95	7.07	60.0	5.30	40
Arcadia ARC4 4 1.68		1.68	12.57	60.0	9.43	40
Arcadia ARC5 5		2.63	19.63	60.0	14.72	40
Arcadia ARC6	6	3.78	28.27	60.0	21.20	40
Arcadia ARC8	8	6.72	50.27	60.0	37.70	40
Arcadia ARC10	10	10.50	78.54	60.0	58.91	40

1. Sediment Removal Interval (months) = (50% HDS MTD Max Sediment Storage Volume * 3.57) / (MTFR * TSS Removal Efficiency) calculated using equation in Appendix B, Part B of the NJDEP HDS Protocol.

PRODUCT SPECIFICATIONS

2. 50% Sediment Storage Capacity is equal to manhole diameter x 9 inches of sediment depth. Each Arcadia unit has an 18-inch deep sediment sump.


Table A-2 Standard Dimensions for Arcadia Models


Model	Manhole Diameter (ft)	NJDEP 50% TSS MTFR (cfs)	Total Chamber Depth (ft)	Treatment Chamber Depth ¹ (ft)	Treatment Chamber Wet Volume ⁴ (ft ³)	Aspect Ratio ² (Depth/Dia.)	Sediment Sump Depth (in)	Maximum Pipe Diamete (in)
Arcadia ARC3	3	0.95	4.58	3.83	27.0	1.275	18.0	18.0
Arcadia ARC4	4	1.68	6.75	6	75.4	1.50	18.0	24.0
Arcadia ARC5	5	2.63	6.75	6	117.8	N/A	18.0	36.0
Arcadia ARC6	6	3.78	6.75	6	169.6	N/A	18.0	42.0
Arcadia ARC8	8	6.72	11.00	10.25	512.8	1.281	18.0	60.0
Arcadia ARC10	10	10.50	13.50	12.75	1001.4	1.275	18.0	72.0


- 1. Treatment chamber depth is defined as the total chamber depth minus ½ the sediment storage depth. 2. The aspect ratio is the unit's treatment chamber depth/diameter. The aspect ratio for the tested unit is 1.50. Larger models (>250%)
- MTFR of the tested unit, > 4.20 cfs) must be geometrically proportionate to the tested unit. A variance of 15% is allowable (1.275
- 3. For units < 250% MTFR (5 and 6 ft models), the depth must be equal or greater than the depth of the unit treated.

4. Referred to as Treatment Chamber Capacity in the ADS Arcadia Maintenance Guide

WATER QUALITY UNIT NOTE: ADS ARCADIA ARC-5 WATER QUALITY UNIT TO BE USED AT STRUCTURE WQ#8 LOCATION. REFER TO CALCULATIONS FOR SIZING ON SHEET C-9.1 NJDEP/NJCAT CERTIFIED FLOW RATES PROVIDED. CONTACT PEA GROUP FOR FULL NJDEP CERTIFICATION LETTER (IF REQUIRED).

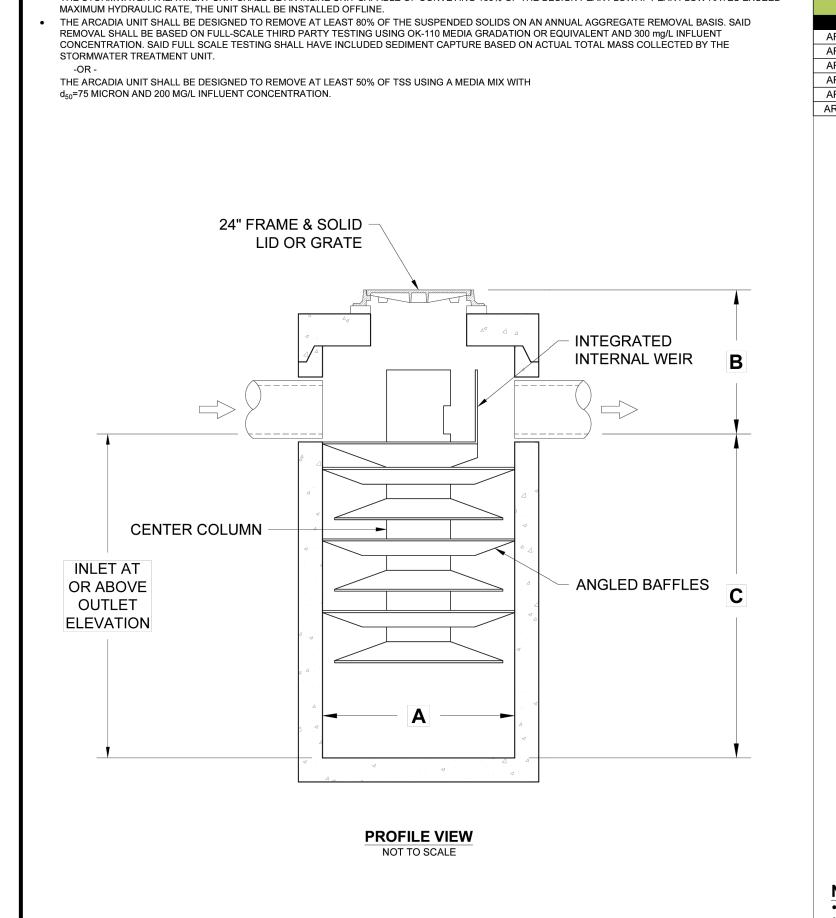

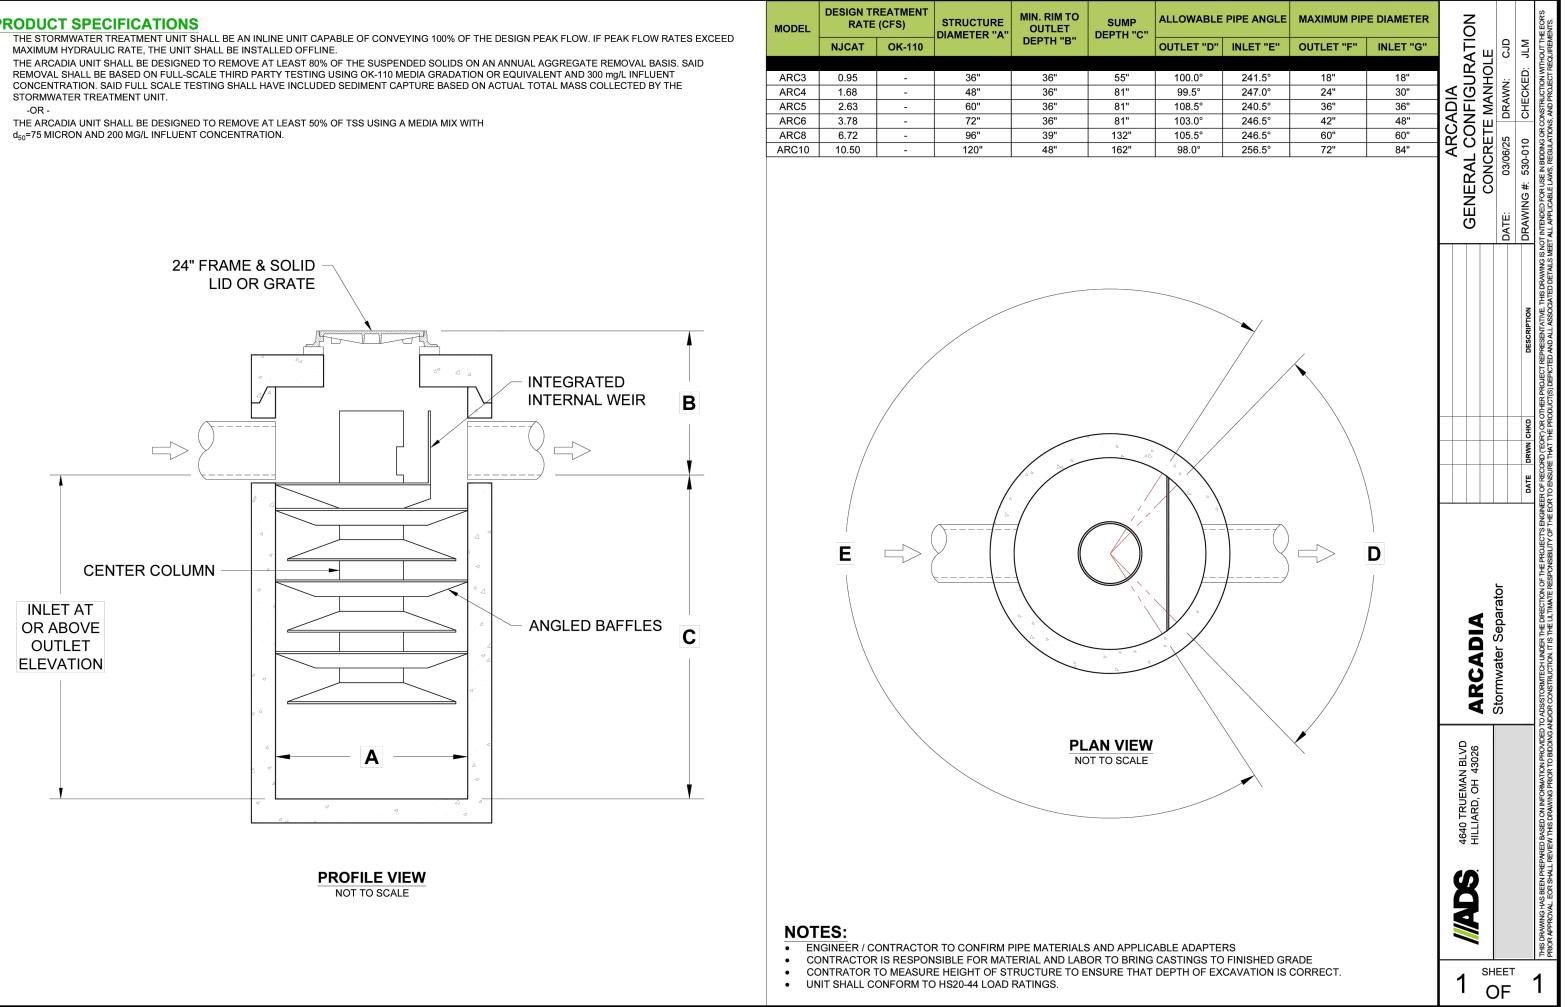

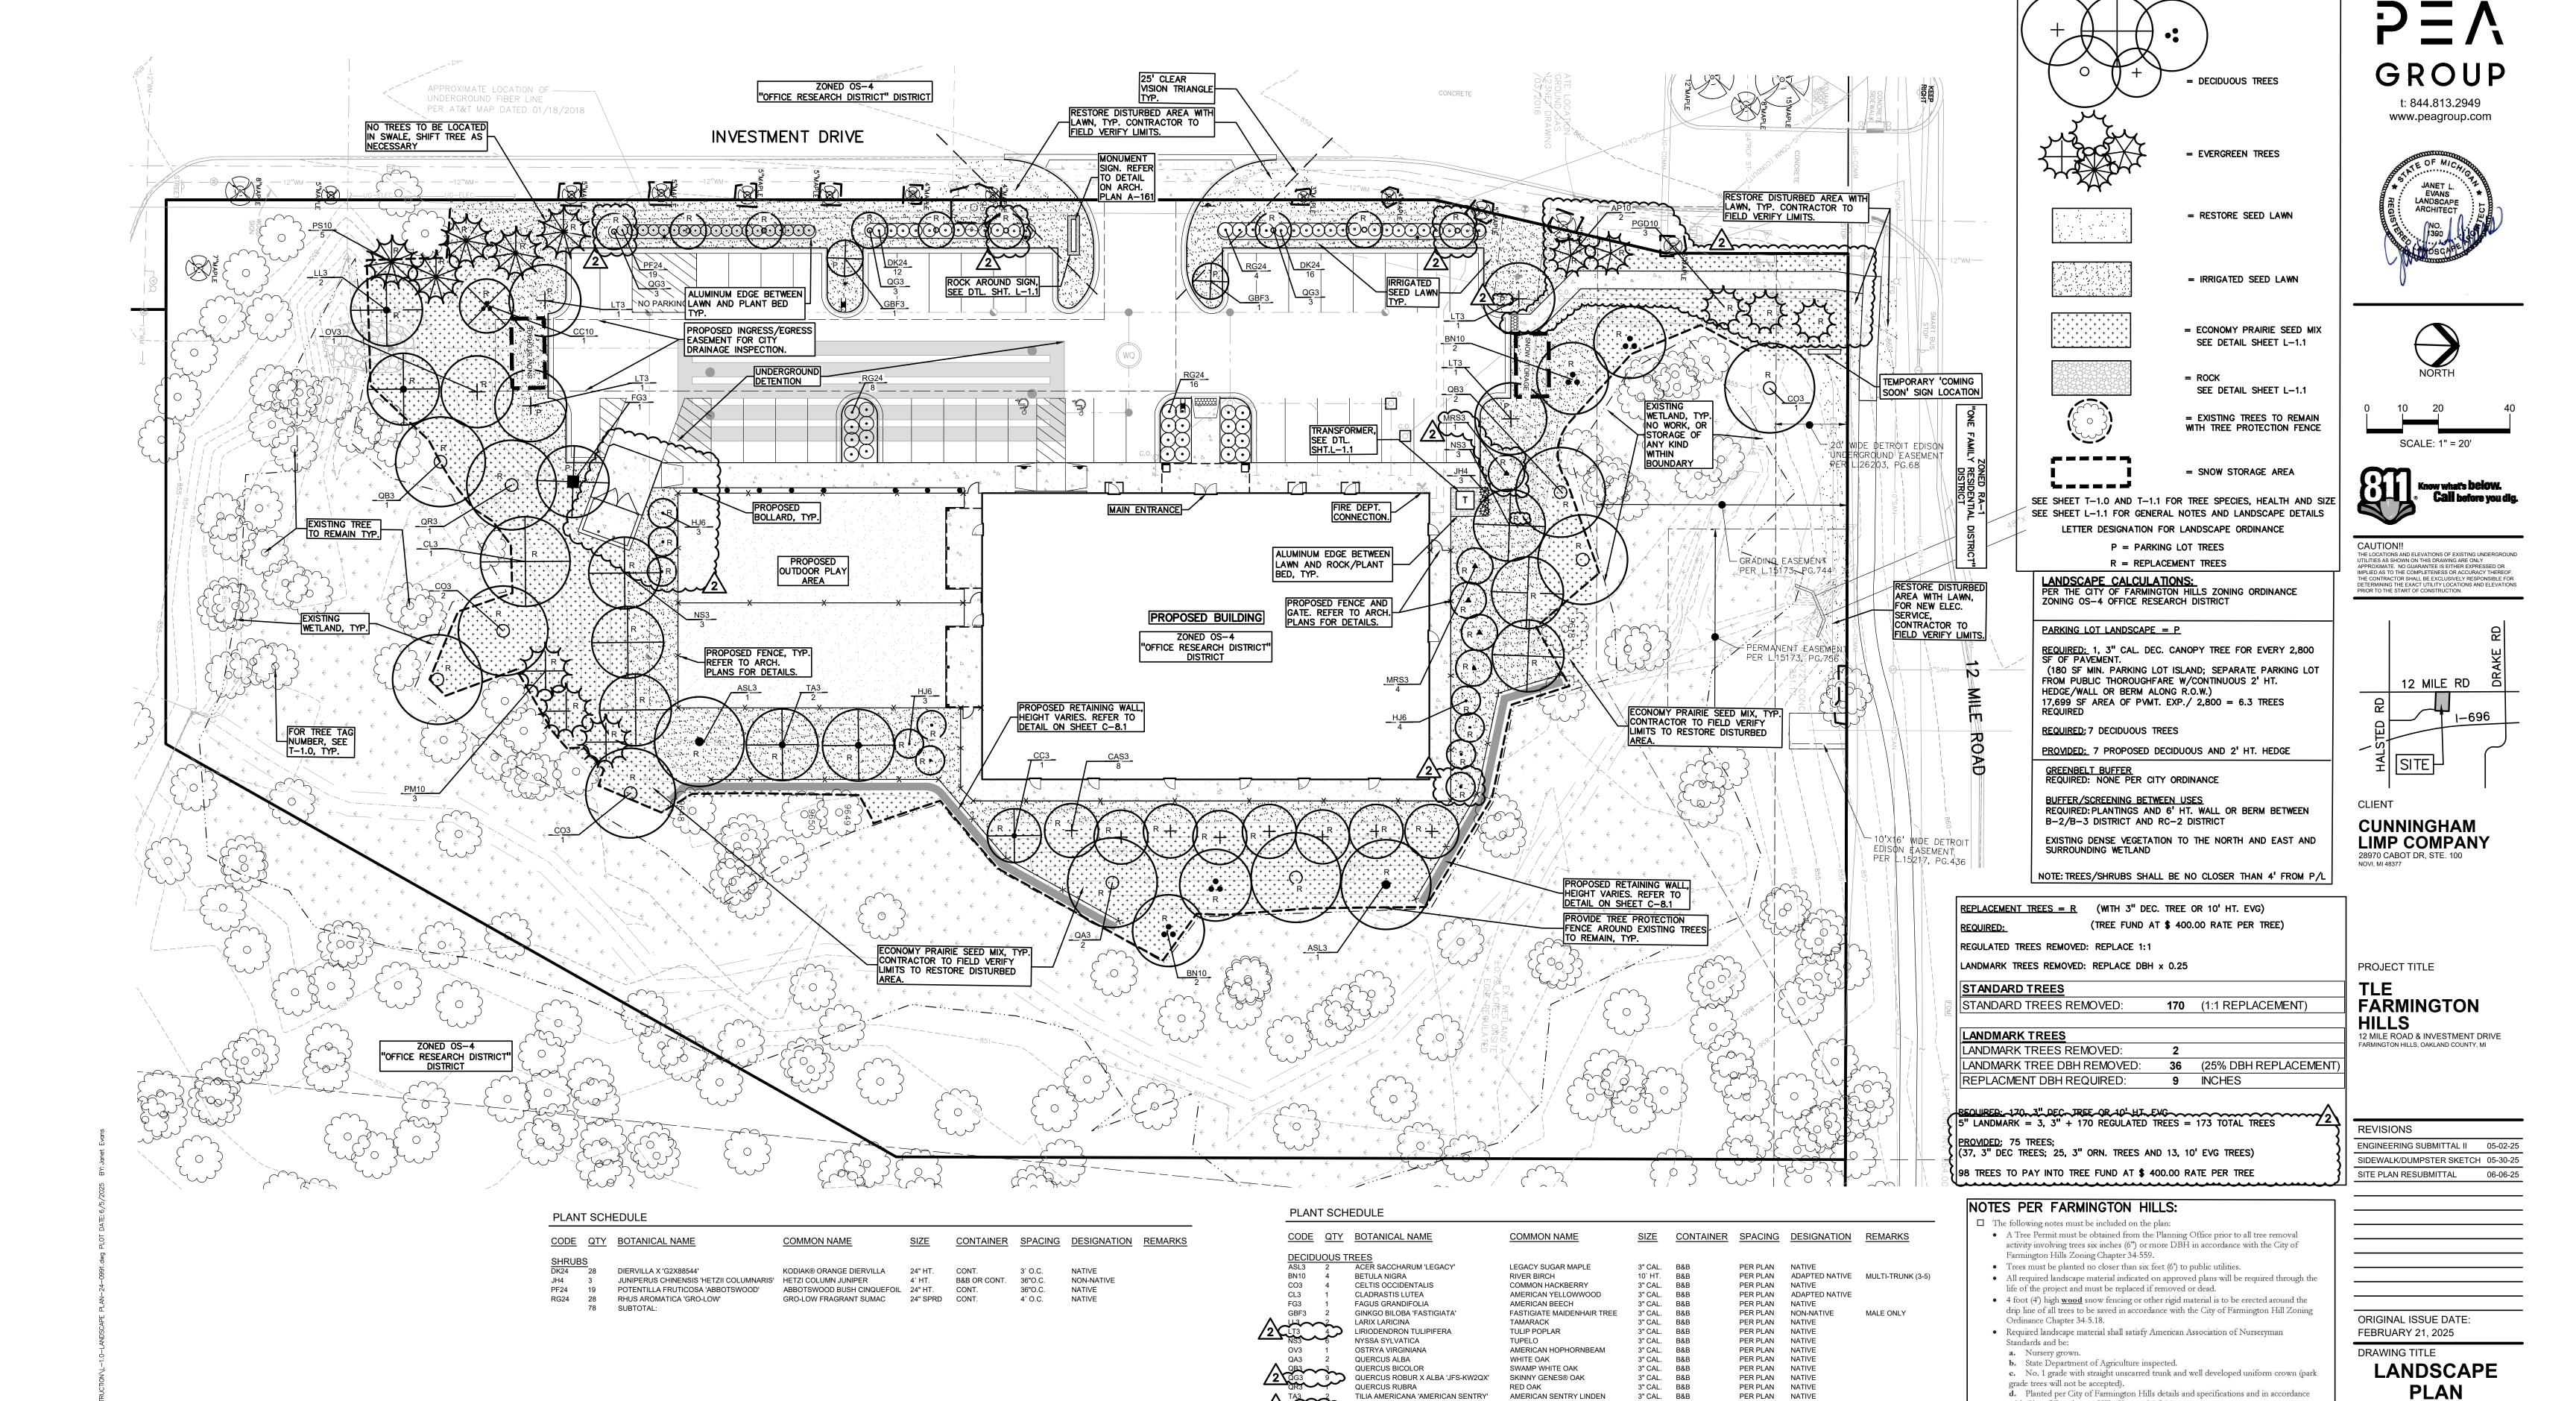

SUBTOTAL:

SUBTOTAL:

ORNAMENTAL TREES
CC10 1 CERCIS CANADENSIS

PGD10

PM10

ABIES BALSAMEA PHANEROLEPIS

HAMAMELIS X INTERMEDIA 'JELENA'

MAGNOLIA STELLATA 'ROYAL STAR'

PICEA GLAUCA 'DENSATA'

PSEUDOTSUGA MENZIESII

PINUS STROBUS

CERCIS CANADENSIS

10` HT. B&B

10` HT. B&B

10` HT. B&B

10` HT. B&B

3" CAL. B&B

6` HT. B&B

3" CAL. B&B

CANAAN BALSAM FIR

BLACK HILLS SPRUCE

EASTERN WHITE PINE

DOUGLAS FIR

EASTERN REDBUD

EASTERN REDBUD

JELENA WITCH HAZEL

ROYAL STAR MAGNOLIA

CORNUS FLORIDA 'APPALACHIAN SPRING' APPALACHIAN SPRING DOGWOOD 3" CAL. B&B

PER PLAN NATIVE

PER PLAN NON-NATIVE

J		
	PEA JOB NO.	24-0991
	P.M.	JRH
	DN.	CAL
	DES.	JLE
	DRAWING NUMBER:	

with City of Farmington Hills Chapter 34-5.14.

f. Replacement trees shall have shade potential and other characteristics comparable

e. Guaranteed for one year.

to the trees proposed for removal.

TRANSFORMER SCREENING DETAIL SCALE: 1'' = 3'-0''

VARIES PER SPECIES SEE PLAN FOR QUANTITY SPECIES SEE PLAN FOR QUANTITY PLANT PERENNIALS EQUAL DISTANCE IN ALL DIRECTIONS ALL SPACING IS TO BE TRIANGULAR UNLESS NOTED OR GRAPHICALLY SHOWN PLAN VIEW 3" SHREDDED BARK MULCH. DO NOT PILE MULCH AGAINST PLANT STEMS

SHOVEL CUT EDGE OR ALUMINUM EDGING AS INDICATED ON PLAN - SPECIFIED PLANTING MIX NOTE: REMOVE ALL CONTAINERS PRIOR SECTION VIEW

VERGREEN TREE PLANTING DETAIL

SCALE: 1'' = 3'-0''

. PLANTING DETAIL

PERMALOC ALUMINUM EDGING OR APPROVED EQUAL WITH BLACK FINISH STAKING/GUYING - COMPACTED SUBGRADE SPECIFICATIONS FOR LANDSCAPE BED EDGING: LANDSCAPE BED EDGING SHALL BE ALUMINUM AS MANUFACTURED BY PERMALOC 1.800.356.9660 8' OR 16' SECTIONS SHALL BE USED WITH ONE STAKE PER 38" OF EDGING SHALL BE 급" THICK X 4" DEPTH WHEN ADJ. TO MULCH AND THICK X 5 1" DEPTH WHEN ADJ. TO ROCK, FINISH: BLACK DURAFLEX MEETING AAMA 2603 STAKE SHALL SECURELY ENGAGE EDGING AND SHALL BE ENTIRELY BELOW TOP SURFACE OF EDGING EDGING SHALL HAVE A MINIMUM OF 2" OF INTERLOCKING OVERLAP BETWEEN SECTIONS

FACE OF BUILDING,

AT 5" DEPTH

CURB, SIGN OR WALK

2"-3" DIA. RIVER ROCK

TURF OR PLANTING BED, SEE

9.25" NON- BENDING STEEL

- STAKES TO BE DRIVEN IN.

MIN. OF 6 PER SECTION.

FABRIC (WEED BARRIER)

SUBGRADE, COMPACT TO

95% MAX. DRY UNIT DENSITY

NON-WOVEN FILTER

(PER ASTM 0-1557)

INSTALL AS PER MANUFACTURER'S SPECIFICATIONS WITH TOP OF

EDGING 4"-1" ABOVE COMPACTED FINISH GRADE. FINISH GRADE TO

BE COMPACTED ON BOTH SIDES OF EDGING TO MAINTAIN STABILITY

ROCK AT SIGN

LUMINUM EDGE DETAIL

SCALE: 1/2'' = 1'-0''

SEE DETAIL THIS SHEET, MIN. 8' SECTIONS

TOP OF EDGING TO BE FLUSH WITH FINISHED

PLANT SO THAT THE TREE'S ROOT FLARE (TRUNK FLARE) IS FLUSH WITH GRADE OR 1-2" HIGHER IN POORLY DRAIN SOIL. STAKE JUST BELOW BRANCHES WITH 2"-3" WIDE NYLON OR PLASTIC STRAPS. CONNECT FROM TREE TO STAKE AND ALLOW FOR FLEXIBILITY. REMOVE AFTER (1) ONE YEAR. (DO NOT USE WIRE & HOSE) THREE 2"X2" HARDWOOD STAKES OR STEEL T-POSTS DRIVEN A MIN. OF 18" DEEP FIRMLY INTO SUBGRADE PRIOR TO BACKFILLING SHREDDED HARDWOOD BARK MULCH TO DRIPLINE. 3" DEEP AND LEAVE 3" CIRCLE OF BARE SOIL AROUND TREE TRUNK. DO NOT

PLACE MULCH IN CONTACT WITH TREE TRUNK. FORM SAUCER WITH 4" HIGH CONTINUOUS RIM

-FINISH GRADE

SPECIFIED PLANTING MIX, WATER & TAMP TO REMOVE AIR POCKETS, AMEND SOIL PER SITE CONDITIONS & TREE REQUIREMENTS EXPOSE ROOT FLARE OF TREE. CONTRACTOR MAY HAVE TO REMOVE EXCESS SOIL FROM -TOP OF ROOTBALL. REMOVE ALL BURLAP FROM TOP $\frac{1}{3}$ OF ROOTBALL. DISCARD ALL NON-BIODEGRADABLE MATERIAL OFF SITE PLACE ROOTBALL ON UNEXCAVATED OR TAMPED SOIL

> TREE PROTECTION DETAIL, PER CITY NOT TO SCALE

PLANT SO THAT TOP OF ROOT BALL IS FLUSH TO GRADE OR 1-2" HIGHER IF IN POORLY DRAINED SOILS

DO NOT COVER TOP OF ROOTBALL WITH SOIL FORM SAUCER WITH 4" HIGH CONTINUOUS RIM SHREDDED HARDWOOD BARK MULCH 3" DEEP AND LEAVE 3" CIRCLE OF BARE SOIL AROUND TRUNK. DO NOT PLACE MULCH IN CONTACT WITH TRUNK - FINISH GRADE

SPECIFIED PLANTING MIX. WATER AND TAMP TO REMOVE AIR POCKETS REMOVE ALL BURLAP FROM TOP 1 OF -ROOTBALL. DISCARD ALL NON-BIODEGRADABLE MATERIAL OFF SITE

PLACE ROOTBALL ON UNEXCAVATED OR

SHRUB PLANTING DETAIL

VARIES ON CONTAINER

OR BALL SIZE

SCALE: 1'' = 2'-0''

PLANT SO THAT THE TREE'S ROOT FLARE (TRUNK FLARE) IS FLUSH WITH GRADE OR 1-2" HIGHER IN POORLY DRAIN SOIL. SECURE TREE WRAP WITH BIODEGRADABLE MATERIAL AT TOP & BOTTOM, REMOVE AFTER FIRST WINTER DO NOT PRUNE TERMINAL LEADER PRUNE ONLY DEAD. BROKEN BRANCHES AS DIRECTED BY LANDSCAPE ARCHITECT STAKE JUST BELOW BRANCHES WITH 2"-3" WIDE NYLON OR PLASTIC STRAPS. CONNECT -FROM TREE TO STAKE AND ALLOW FOR FLEXIBILITY. REMOVE AFTER (1) ONE YEAR. (DO NOT USE WIRE & HOSE) (3) THREE 2"X2" HARDWOOD STAKES DRIVEN A MIN. OF 18" DEEP FIRMLY INTO SUBGRADE PRIOR TO BACKFILLING SHREDDED HARDWOOD BARK MULCH TO 120° DRIPLINE. 3" DEEP AND LEAVE 3" CIRCLE OF BARE SOIL AROUND TREE TRUNK, DO NOT STAKING/GUYING PLACE MULCH IN CONTACT WITH TREE **LOCATION** TRUNK. FORM SAUCER WITH 4" HIGH CONTINUOUS RIM SPECIFIED PLANTING MIX, WATER & TAMP TO -REMOVE AIR POCKETS, AMEND SOIL PER SITE CONDITIONS & TREE REQUIREMENTS EXPOSE ROOT FLARE OF TREE. CONTRACTOR MAY HAVE TO REMOVE EXCESS SOIL FROM - TOP OF ROOTBALL. REMOVE ALL BURLAP FROM TOP 1 OF ROOTBALL, DISCARD ALL NON-BIODEGRADABLE MATERIAL OFF SITE _ PLACE ROOTBALL ON UNEXCAVATED OR TAMPED SOIL

_4' HT. PROTECTIVE WOOD SNOW

FENCE OR SIMILAR STURDY

STOCK MATERIAL WITH METAL

STAKES, 10' O.C. NO CLOSER

THAN 6' FROM TRUNK OR AT

THE DRIP LINE, WHICHEVER IS

GREATER PER FARMINGTON HILLS

FENCE SHALL BE PLACED IN A

PER 1" DIAMETER OF THE TREE

CIRCLE WITH A RADIUS OF 1'

MEASURED AT 4.5' ABOVE

GROUND.

<u>DECIDUOUS TREE PLANTING DETAIL</u>

TREE PROTECTION NOTES:

TREE PROTECTION WILL BE ERECTED PRIOR TO START OF CONSTRUCTION ACTIVITIES AND SHALL REMAIN IN PLACE UNTIL CONSTRUCTION IS COMPLETE.

- ON PERSON MAY CONDUCT ANY ACTIVITY WITHIN THE DRIP LINE OF ANY TREE DESIGNATED TO REMAIN; INCLUDING, BUT NOT LIMITED TO PLACING SOLVENTS, BUILDING MATERIAL, CONSTRUCTION EQUIPMENT, OR SOIL DEPOSITS WITHIN DRIP LINES.
- GRADE CHANGES MAY NOT OCCUR WITHIN THE DRIP LINE OF PROTECTED TREES. DURING CONSTRUCTION, NO PERSON SHALL ATTACH ANY DEVICE OR WIRE TO ANY
- ALL UTILITY SERVICE REQUESTS MUST INCLUDE NOTIFICATION TO THE INSTALLER THAT PROTECTED TREES MUST BE AVOIDED. ALL TRENCHING SHALL OCCUR OUTSIDE OF THE PROTECTIVE FENCING.
- TREES LOCATED ON ADJACENT PROPERTY THAT MAY BE AFFECTED BY CONSTRUCTION ACTIVITIES MUST BE PROTECTED.
- TREES TO BE REMOVED SHALL BE MARKED IN THE FIELD WITH RED PAINT OR

FLAGS AND INSPECTED BY FARMINGTON HILLS PLANNING OFFICE PRIOR TO ANY TREES BEING REMOVED. A TREE PERMIT MUST BE OBTAINED FROM THE PLANNING DEPT PRIOR TO ANY TREES BEING REMOVED.

NATIVE SEED MIX, BY STANTEC NATIVE PLANT NURSERY, 574-586-2412, OR EQUAL SPECIES TO BE NATIVE TO COUNTY, NO INVASIVE SPECIES ALLOWED

FOR ALL SEED MIXES, PROVIDE EROSION MAT ON SLOPES AND AREAS OF WASH OUT TYP INSTALL AND PREP PER MANUFACTURES SPECIFICATIONS. Economy Prairie Seed Mix

Stantec Native Plant Nursery 574-586-2412 stantec.com/native-plant-nursery **Botanical Name** Common Name

Permanent Grasses/Sedges/Rushes Big Bluestem Andropogon gerardii

Bouteloua curtipendula Side Oats Grama Carex spp. Prairie Sedge Mix Canada Wild Rye Elymus canadensis Panicum virgatum Switch Grass Schizachyrium scoparium Little Bluestem Indian Grass Sorghastrum nutans

Temporary Cover: Avena sativa Common Oat Annual Rye Lolium multiflorum

Forbs & Shrubs: Asclepias syriaca Common Milkweed Asclepias tuberosa Butterfly Weed Chamaecrista fasciculata Partridge Pea Coreopsis lanceolata Sand Coreopsis Echinacea purpurea Broad-leaved Purple Coneflower False Sunflower Heliopsis helianthoides Lupinus perennis Wild Lupine Monarda fistulosa Wild Bergamot Foxglove Beard Tongue Penstemon digitalis

Pycnanthemum virginianum Common Mountain Mint Yellow Coneflower Ratibida pinnata Rudbeckia hirta Black-Eyed Susan Solidago speciosa Showy Goldenrod Smooth Blue Aster Symphyotrichum laeve New England Aster Symphyotrichum novae-angliae

GENERAL PLANTING NOTES:

- LANDSCAPE CONTRACTOR SHALL VISIT SITE, INSPECT EXISTING SITE CONDITIONS AND REVIEW PROPOSED PLANTING AND RELATED WORK. IN CASE OF DISCREPANCY BETWEEN PLAN AND PLANT LIST, PLAN SHALL GOVERN QUANTITIES. CONTACT LANDSCAPE ARCHITECT WITH ANY CONCERNS.
- CONTRACTOR SHALL VERIFY LOCATIONS OF ALL ON SITE UTILITIES PRIOR TO BEGINNING CONSTRUCTION ON HIS/HER PHASE OF WORK. ELECTRIC, GAS, TELEPHONE, CABLE TELEVISION MAY BE LOCATED BY CALLING MISS DIG 1-800-482-7171. ANY DAMAGE OR INTERRUPTION OF SERVICES SHALL BE THE RESPONSIBILITY OF CONTRACTOR. CONTRACTOR SHALL COORDINATE ALL RELATED ACTIVITIES WITH OTHER TRADES ON THE JOB AND SHALL REPORT ANY UNACCEPTABLE JOB CONDITIONS TO OWNER'S REPRESENTATIVE PRIOR TO
- 3. ALL PLANT MATERIAL TO BE PREMIUM GRADE NURSERY STOCK AND SHALL SATISFY AMERICAN ASSOCIATION OF NURSERYMEN STANDARD FOR NURSERY STOCK. ALL LANDSCAPE MATERIAL SHALL BE NORTHERN GROWN, NO.
- CONTRACTOR IS RESPONSIBLE FOR VERIFYING ALL QUANTITIES SHOWN ON LANDSCAPE PLAN PRIOR TO PRICING THE WORK.
- THE OWNER'S REPRESENTATIVE RESERVES THE RIGHT TO REJECT ANY PLANT MATERIAL NOT MEETING
- ALL SINGLE STEM SHADE TREES TO HAVE STRAIGHT

TRUNKS AND SYMMETRICAL CROWNS.

- ALL SINGLE TRUNK SHADE TREES TO HAVE A CENTRAL LEADER; TREES WITH FORKED OR IRREGULAR TRUNKS WILL NOT BE ACCEPTED.
- ALL MULTI STEM TREES SHALL BE HEAVILY BRANCHED AND HAVE SYMMETRICAL CROWNS. ONE SIDED TREES
- OR THOSE WITH THIN OR OPEN CROWNS SHALL NOT BE . ALL EVERGREEN TREES SHALL BE HEAVILY BRANCHED AND FULL TO THE GROUND, SYMMETRICAL IN SHAPE

AND NOT SHEARED FOR THE LAST FIVE GROWING

SEASONS. 10. ALL TREES TO HAVE CLAY OR CLAY LOAM BALLS,

TREES WITH SAND BALLS WILL BE REJECTED.

- 1. NO MACHINERY IS TO BE USED WITHIN THE DRIP LINE OF EXISTING TREES; HAND GRADE ALL LAWN AREAS WITHIN THE DRIP LINE OF EXISTING TREES.
- 12. ALL TREE LOCATIONS SHALL BE STAKED BY LANDSCAPE CONTRACTOR AND ARE SUBJECT TO THE APPROVAL OF THE LANDSCAPE ARCHITECT PRIOR TO INSTALLATION OF THE PLANT MATERIAL.
- 13. IT IS MANDATORY THAT POSITIVE DRAINAGE IS PROVIDED AWAY FROM ALL BUILDINGS.
- 14. ALL PLANTING BEDS SHALL RECEIVE 3" SHREDDED HARDWOOD BARK MULCH WITH PRE EMERGENT, SEE SPECIFICATIONS. SHREDDED PALETTE AND DYED MULCH WILL NOT BE ACCEPTED.
- 15. ALL LANDSCAPED AREAS SHALL RECEIVE 3" COMPACTED
- 16. SEE SPECIFICATIONS FOR ADDITIONAL COMMENTS, REQUIREMENTS, PLANTING PROCEDURES AND WARRANTY
- 17. FOR NON—LAWN SEED MIX AREAS, AS NOTED ON PLAN, BRUSH MOW ONCE SEASONALLY FOR INVASIVE SPECIES
- 8. CONTRACTOR SHALL NOT INSTALL PLANTS UNDER BUILDING OVERHANG AND SHALL NOTIFY LANDSCAPE ARCHITECT IF DRAWINGS CONFLICT WITH BUILDING OVERHANGS.
- 19. TREES SHALL NOT CONFLICT/ BLOCK PROPOSED REGULATORY/ DIRECTION SIGNAGE, MONUMENT SIGNS, ADDRESS OR LIGHT POLES. SHIFT TREES AS NECESSARY

GROUP


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CLIENT

CUNNINGHAM LIMP COMPANY

PROJECT TITLE


FARMINGTON 12 MILE ROAD & INVESTMENT DRIVE FARMINGTON HILLS, OAKLAND COUNTY, MI

REVISIONS	
ENGINEERING SUBMITTAL II	05-02-2
SIDEWALK/DUMPSTER SKETCH	05-30-2
SITE PLAN RESUBMITTAL	06-06-2
	•

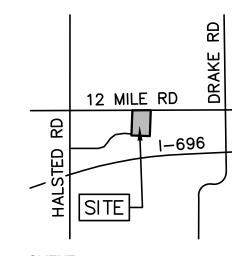ORIGINAL ISSUE DATE: FEBRUARY 21, 2025 DRAWING TITLE

LANDSCAPE DETAILS

PEA JOB NO. 24-0991 P.M. JRH CAL DES. DRAWING NUMBER:

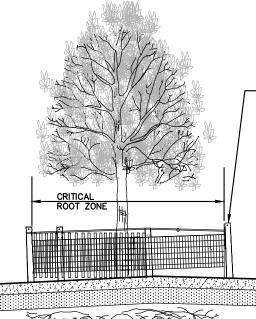

NOT TO SCALE

LANDMARK TREE # 9742

_4' HT. PROTECTIVE WOOD SNOW FENCE OR SIMILAR STURDY STOCK MATERIAL WITH METAL STAKES, 10' O.C. NO CLOSER THAN 6' FROM TRUNK OR AT THE DRIP LINE, WHICHEVER IS GREATER <u>PER FARMINGTON HILL</u>S.

TREE PROTECTION DETAIL, PER CITY

FENCE SHALL BE PLACED IN A CIRCLE WITH A RADIUS OF 1' PER 1" DIAMETER OF THE TREE MEASURED AT 4.5' ABOVE GROUND.

TREE PROTECTION NOTES:

- TREE PROTECTION WILL BE ERECTED PRIOR TO START OF CONSTRUCTION ACTIVITIES AND SHALL REMAIN IN PLACE UNTIL CONSTRUCTION IS COMPLETE.
- NO PERSON MAY CONDUCT ANY ACTIVITY WITHIN THE DRIP LINE OF ANY TREE DESIGNATED TO REMAIN; INCLUDING, BUT NOT LIMITED TO PLACING SOLVENTS, BUILDING MATERIAL, CONSTRUCTION EQUIPMENT, OR SOIL DEPOSITS WITHIN DRIP LINES.
- GRADE CHANGES MAY NOT OCCUR WITHIN THE DRIP LINE OF PROTECTED TREES. DURING CONSTRUCTION, NO PERSON SHALL ATTACH ANY DEVICE OR WIRE TO ANY
- REMAINING TREE. • ALL UTILITY SERVICE REQUESTS MUST INCLUDE NOTIFICATION TO THE INSTALLER
- THAT PROTECTED TREES MUST BE AVOIDED. ALL TRENCHING SHALL OCCUR OUTSIDE OF THE PROTECTIVE FENCING. TREES LOCATED ON ADJACENT PROPERTY THAT MAY BE AFFECTED

BY CONSTRUCTION ACTIVITIES MUST BE PROTECTED.

TREES TO BE REMOVED SHALL BE MARKED IN THE FIELD WITH RED PAINT OR FLAGS AND INSPECTED BY FARMINGTON HILLS PLANNING OFFICE PRIOR TO ANY TREES BEING REMOVED. A TREE PERMIT MUST BE OBTAINED FROM THE PLANNING DEPT PRIOR TO ANY TREES BEING REMOVED.

EXISTING TREE TO BE REMOVED TYP.

PROVIDE TREE PROTECTION

FENCE AROUND EXISTING TREES
TO REMAIN, TYP.

REGULATED TREE = ANY TREE 6" CAL. AND ABOVE IN GOOD-POOR CONDITION REGULATED TREE; REPLACE AT 1:1

LANDMARK TREE; REPLACE AT 25% OF DBH OF REMOVED TREE

STANDARD TREES

STANDARD TREES REMOVED: **170** (1:1 REPLACEMENT)

 $\sqrt{2}$

LANDMARK TREES LANDMARK TREES REMOVED: LANDMARK TREE DBH REMOVED: 36 (25% DBH REPLACEMENT

REPLACMENT DBH REQUIRED:

9 INCHES

KEY:

= EXISTING TREE TO REMAIN AND CORRESPONDING TREE TAG

= EXISTING TREE TO BE REMOVED AND CORRESPONDING TREE TAG




= LANDMARK TREE


— — = TREE PROTECTION FENCING

REFER TO SHEET T-1.1 AND T-1.2 FOR EXISTING TREE LIST REFER TO SHEET L-1.0 FOR TREE REPLACEMENT INFORMATION THIS SITE: TREE TAG NUMBERS 3035 -10000






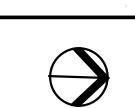

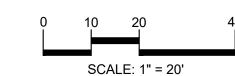



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CUNNINGHAM LIMP COMPANY 28970 CABOT DR, STE. 100 NOVI, MI 48377

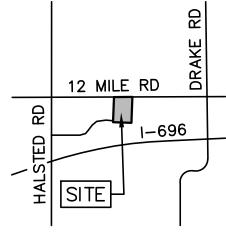PROJECT TITLE

REVISIONS

TLE
FARMINGTON
HILLS
12 MILE ROAD & INVESTMENT DRIVE
FARMINGTON HILLS, OAKLAND COUNTY, MI

ENGINEERING SUBMITTAL II	05-02-25
SIDEWALK/DUMPSTER SKETCH	05-30-25
SITE PLAN RESUBMITTAL	06-06-25

ORIGINAL ISSUE DATE: FEBRUARY 21, 2025 DRAWING TITLE

TREE PRESERVATION PLAN

PE	EA JOB NO.	24-0991
P.I	М.	JRH
DN	l.	CAL
DE	S.	JLE

TAG NO.	DBH	COMMON NAME	LATIN NAME	CLASS	CONDITION	COMMENTS	trunk	growth rate	1	TION/ FACTOR		life exp.	OVERALL RANK	SAVE /	REPLACE
9593	11	Sugar Maple	Acer saccharum	WOODLA ND	Fair		4	5	4	5	3	4	25	S	-
9594 9595	10 14	Sugar Maple American ⊟m	Acer saccharum Ulmus americana	WOODLAND WOODLAND	Good Fair		5	5	5	5	2	5	29	S S	-
9596	7.5	Sugar Maple	Acer saccharum	WOODLAND WOODLAND	Fair		5	3	5	5	3	4	25	S	-
9597	9	Sugar Maple	Acer saccharum	WOODLAND	Good		5	4	5	5	3	5	27	S	-
9598 9599	10 9	Sugar Maple Sugar Maple	Acer saccharum Acer saccharum	WOODLA ND WOODLA ND	Good Excellent		5	4	5 4	5	4	5	28	S	-
9600	8.5	Sugar Maple	Acer saccharum	WOODLA ND	Good		5	5	5	5	3	5	28	S	-
9601	6.5	Sugar Maple	Acer saccharum	WOODLAND	Good		5	5	5	5	3	5	28	S	-
9602 9603	11.5 6.5	Black Locust Black Locust	Robinia pseudoacacia Robinia pseudoacacia	WOODLA ND WOODLA ND	Good Fair		5	3	3	5	2	2	26	S	-
9604	13.5	Black Locust	Robinia pseudoococia	WOODLA ND	Good		5	5	5	5	3	3	26	S	-
9605 9606	11 15.5	Black Locust American Em	Robinia pseudoacacia Ulmus americana	WOODLA ND	Fair Fair	Inner Bark Rot	4	3 5	3	5	3	3	19	S	-
9607	6	American ⊟m	Ulmus americana	WOODLAND WOODLAND	Fair	Leaning	4	3	4	5	4	3	23	S	-
9608	21.5	American ⊟m	Ulmus americana	WOODLA ND	Good		4	5	4	3	4	3	23	S	-
9609 9610	6.5 6	Sugar Maple Common Buckthorn	Acer saccharum Rhamnus cathortica	WOODLA ND WOODLA ND	Good Fair	2T	5	5	4	5	3	3	26	S	-
9611	8.5	Box-⊟der Maple	Acer negundo	WOODLAND	Good		5	5	5	5	3	4	27	S	-
9612	8	Box-⊟der Maple	Acer negundo	WOODLAND	Good		5	5	5	5	4	5	29	S	-
9613 9614	7.5 9.5	Cottonw ood Cottonw ood	Populus deltoides Populus deltoides	WOODLA ND WOODLA ND	Good		5	5	4	5	4	5	28	S	-
9615	6	Common Buckthorn	Rhamnus cathartica	WOODLA ND	Good		4	3	3	5	3	3	21	S	-
9616 9617	6 7	Sugar Maple	Acer saccharum	WOODLA ND	Good Good		5	5	5	5	4	5	29	S	-
9618	16	Sugar Maple American ⊟m	Acer saccharum Ulmus americana	WOODLAND WOODLAND	Excellent		5	5	5	5	5	4	29	S	-
9619	7	Sugar Maple	Acer saccharum	WOODLAND	Good		5	5	5	5	4	5	29	R	REPLA CE
9620 9621	7 7.5	Black Cherry Sugar Maple	Prunus serotina Acer saccharum	WOODLAND WOODLAND	Good Good		5	5	5 4	5	4	5	29	R	REPLACE REPLACE
9622	6.5	Sugar Maple	Acer saccharum	WOODLAND	Good		5	5	4	5	4	5	28	R	REPLACE
9623	8.5	Sugar Maple	Acer saccharum	WOODLAND	Good		5	5	4	5	4	5	28	R	REPLACE
9624 9625	13 8	Red Maple Common Buckthorn	Acer rubrum Rhamnus cathartica	WOODLAND WOODLAND	Good Fair		5	5	5 3	5	3	3	28	R	REPLACE REPLACE
9626	9.5	Black Cherry	Prunus seratina	WOODLAND	Good		5	5	4	5	4	4	27	R	REPLACE
9627	10.5	Sugar Maple	Acer saccharum	WOODLAND	Excellent		5	5	5	5	5	5	30	R	REPLACE
9628 9629	6 9	Common Buckthorn Box-Elder Maple	Rhamnus cathartica Acer negundo	WOODLAND WOODLAND	Fair Good		5	5	4	5	4	3 4	26	R	REPLACE REPLACE
9630	7.5	Box-⊟der Maple	Acer negundo	WOODLAND	Fair		4	5	3	5	3	3	23	S	-
9631 9632	6.5 6	Box-⊟der Maple	Acer negundo	WOODLAND WOODLAND	Good Good	Leaning	5	5	3 5	5	2 4	3 5	22	S	-
9633	7	Box-⊟der Maple American ⊟m	Acer negundo Ulmus americana	WOODLAND	Fair		4	5	3	5	2	3	29	S	-
9634	11	Box-⊟der Maple	Acer negundo	WOODLAND	Good		5	5	4	5	4	3	26	R	REPLACE
9635 9636	11 12	Box-Elder Maple Black Cherry	Acer negundo Prunus serotina	WOODLAND WOODLAND	Good Good	2 T	5	5	3	5	4	3	25	R	REPLACE REPLACE
9637	11	Sugar Maple	Acer saccharum	WOODLAND	Good	21	5	5	5	5	4	4	28	R	REPLACE
9638	7.5	Sugar Maple	Acer saccharum	WOODLAND	Good		5	5	5	5	4	5	29	R	REPLA CE
9639 9640	11.5 8.5	Black Cherry Black Cherry	Prunus serotina Prunus serotina	WOODLAND WOODLAND	Good Fair		5	5	5 3	5	2	5	29	R	REPLACE REPLACE
9641	15	Black Cherry	Prunus serotina	WOODLAND	Good		5	5	4	5	4	3	26	R	REPLA CE
9642	9.5	American ⊟m	Ulmus americana	WOODLAND	Good		5	5	5	5	4	5	29	R	REPLACE
9643 9644	11 7.5	Box-Elder Maple Black Cherry	Acer negundo Prunus serotina	WOODLAND WOODLAND	Fair Good	2T, Leaning	5	5	5	5	s 4	5	23	S	- REPLACE
9645	6	Black Cherry	Prunus serotina	WOODLAND	Fair		5	3	4	5	3	3	23	R	REPLACE
9646	7.5	Red Maple	Acer rubrum	WOODLAND	Good	27	5	5	3	5	3	4	25	R	REPLACE
9647 9648	9 10	Eastern Red Cedar Sugar Maple	Juniperus virginiona Acer saccharum	WOODLAND WOODLAND	Good Fair		5	5	4	5 3	3	3	25	R S	REPLACE -
9649	8.5	Black Cherry	Prunus serotina	WOODLA ND	Fair		4	5	3	3	3	3	21	S	-
9650 9651	12.5 8.5	Black Cherry White Pine	Prunus serotina Pinus strobus	WOODLAND WOODLAND	Fair Fair		5	5	3	5	3	3	21	S	-
9652	9.5	Black Cherry	Prunus serotina	WOODLAND	Good		5	3	4	5	4	3	24	S	-
9653	8	American ⊟m	Ulmus americana	WOODLA ND	Good		5	5	4	5	4	5	28	S	-
9654 9655	7.5 8.5	Black Cherry Black Cherry	Prunus serotina Prunus serotina	WOODLA ND	Good	Inner Bark Rot	5	5	1	5	3	3	25	S	-
9656	14.5	Sugar Maple	Acer saccharum	WOODLAND	Good	23111101	4	5	5	5	4	4	27	S	-
9657	6	Common Buckthorn	Rhamnus cathartica	WOODLAND	Fair		4	3	3	5	3	4	22	S	-
9663 9682	11.5 6	Sugar Maple Common Buckthorn	Acer saccharum Rhamnus cathartica	WOODLAND WOODLAND	Good Fair		3	5	3	5	3	3	28	S S	-
9691	13	Cottonw ood	Popu/us de/toides	WOODLA ND	Good		5	5	4	5	S	4	23	S	-
9692 9693	7.5 8	Cottonw ood Cottonw ood	Popu/us de/toides Popu/us de/toides	WOODLAND WOODLAND	Good Excellent	2T	5	5	4 5	5	s 5	5	30	S S	-
9693	7.5	Green Ash	Fraxinus pennsylvanica	WOODLAND WOODLAND	Dead		1	1	1	3	1	1	8	S	-
9695	6	Black Ash	Fraxinus nigra	WOODLAND	Fair		4	3	4	5	4	3	23	S	-
9696 9697	9.5	Common Buckthorn Black Ash	Rhamnus cathartica Fraxinus nigra	WOODLA ND	Fair Fair		4	3 4	4	5	3	3 2	23	S	-
9698	11.5	American Em	Ulmus americana	WOODLAND	Fair		4	5	4	3	4	3	23	S	-
9699	6	Cottonw ood	Popu/us de/toides	WOODLAND	Poor		2	3	3	3	2	2	15	S	-
9700 9701	8 6.5	Cottonw ood Cottonw ood	Pop u/us de/toides Popu/us de/toides	WOODLA ND WOODLA ND	Poor Good		5	5	1 4	5	4	5	12 28	S	-
9702	6	Cottonw ood	Pop ulus deltoides	WOODLAND	Good		5	5	4	5	4	5	28	S	-
9703	7	Cottonw ood	Popu/us de/toides	WOODLAND	Good		5	5	4	5	3	4	26	S	-
9704 9705	11 6.5	Cottonw ood Cottonw ood	Popu/us de/toides Pop ulus deltoides	WOODLAND WOODLAND	Good Good		5	5	5	5	5 4	5	29	S S	-
9706	7.5	Cottonw ood	Popu/us de/toides	WOODLA ND	Good		5	5	5	5	4	5	29	S	-
9707 9708	8.5 10	Cottonw ood Cottonw ood	Pop u/us de/toides Populus de/toides	WOODLA ND	Good Poor		5	5 4	5 4	5	4	5	29	S S	-
9708	9.5	Sugar Maple	Acer saccharum	WOODLAND WOODLAND	Fair		3	3	3	5	2	2	18	S	-
9710	6	Sugar Maple	Acer saccharum	WOODLA ND	Fair		5	5	4	5	2	3	24	S	-
9711 9712	11 12.5	Sugar Maple Black Cherry	Acer saccharum Prunus serotina	WOODLAND WOODLAND	Good Poor	2T	4	5	4	5	4	5	6	S S	-
	6.5	Bassw ood	Tilia americana	WOODLAND WOODLAND	Good		5	5	3	5	3	3	24	S	-
9713	6.5	Sugar Maple	Acer saccharum	WOODLA ND	Good		5	5	5	5	4	5	29	S	-
9714		,	Popu/us de/toides	WOODLA ND	Good	1	5	5	5	5	4 s	5	29 25	S S	-
9714 9715	10.5	Cottonw ood Norw ay Spruce		/V/UUUI v viiu	Evenlost	1		1 -		1	. S	. 1	/ 1		_
9714		Cottonw ood Norw ay Spruce Norw ay Spruce	Picea abies Picea abies	WOODLAND WOODLAND	Excellent Excellent		5	5	5	5	5	5	30	S	-
9714 9715 9716 9717 9718	10.5 8.5 11.5	Norw ay Spruce Norw ay Spruce Norw ay Spruce	Acea abies Acea abies Acea abies	WOODLAND WOODLAND	Excellent Excellent		5	5	5	5		5	30 25	S S	-
9714 9715 9716 9717 9718 9719	10.5 8.5 11.5 11	Norw ay Spruce Norw ay Spruce Norw ay Spruce Norw ay Spruce	Picea abies Picea abies Picea abies Picea abies	WOODLAND WOODLAND	Excellent Excellent Excellent		5 5 5	5 5 5	5 5 5	5 5 5	5 s	5 5 5	30 25 25	\$ \$ \$	
9714 9715 9716 9717 9718	10.5 8.5 11.5	Norw ay Spruce Norw ay Spruce Norw ay Spruce	Acea abies Acea abies Acea abies	WOODLAND WOODLAND	Excellent Excellent		5	5	5	5	5 s	5	30 25	S S	- - - REPLACE








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CLIENT

CUNNINGHAM LIMP COMPANY 28970 CABOT DR, STE. 100 NOVI, MI 48377

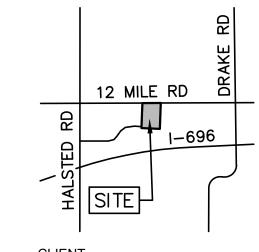PROJECT TITLE

TLE
FARMINGTON
HILLS
12 MILE ROAD & INVESTMENT DRIVE
FARMINGTON HILLS, OAKLAND COUNTY, MI

•	
REVISIONS	
ENGINEERING SUBMITTAL II	05-02-25
SIDEWALK/DUMPSTER SKETCH	05-30-25
SITE PLAN RESUBMITTAL	06-06-25

ORIGINAL ISSUE DATE: FEBRUARY 21, 2025 DRAWING TITLE

EXISTINGTREE LIST

PEA JOB NO.	24-0991
P.M.	JRH
DN.	CAL
DES.	JLE
DRAWING NUMBER:	

NO .	11 11	Norw ay Spruce	LATIN NAME Picea abies	CLASS WOODLAND	Excellent	COMMENTS	trunk	growth rate	structure 5	insects/ diseases crown dev	life exp.	RANK 25	REMOVE S	REP
9726	6.5	Sugar Maple	Acer saccharum	WOODLAND	Good		5	5	5	5 4	4	28	S	
9727 9728	6 13	Sugar Maple American ⊟m	Acer saccharum Ulmus americana	WOODLAND WOODLAND	Good Fair		5	5	5	5 4	3	28	S S	
9729	12.5	Sugar Maple	Acer saccharum	WOODLAND	Good		5	4	4	5 s	4	22	R	RE
9730	8	Sugar Maple	Acer saccharum	WOODLAND	Good		5	5	5	5 4	5	29	R	RE
9731	9	Sugar Maple Fastern Red Cedar	Acer saccharum	WOODLAND WOODLAND	Good		5	5	5	5 5	5	21	R	REI REI
9732 9733	48	Eastern Red Cedar Sugar Maple	Juniperus virginiana Acer saccharum	LANDMARK	Good	2Ţ	4	~~~~~~~~~~~~~~~~~~~~~~~~~~~~~~~~~~~~~~	4	5	4	27	R	RE
9734	13	Black Cherry	Prunus serotina	WOODLAND	Fair	~~~~~	3	3	2	3 2	$\frac{2}{2}$	15	wşw.	<u>~~</u>
9735	6.5	Sugar Maple	Acer saccharum	WOODLAND	Good		5	5	5	5 4	5	29	R	RE
9736 9737	45 6	Red Oak Black Cherry	Quercus rubra Prunus serotina	WOODLAND WOODLAND	Good Fair		5	5	5	5 5	3	29	R	RE
9738	17	Black Cherry	Prunus serotina	WOODLAND	Fair	2T	4	4	3	3 3	3	20	S	
9739	9	Black Cherry	Prunus serotina	WOODLAND	Fair		4	4	4	3 2	3	20	S	
9740	10	Black Cherry	Prunus serotina	WOODLAND	Poor	Inne r Ba rk Rot	2	4	4	5 3	3	21	S	
9741	6.5	Sugar Maple	Acer saccharum	WOODLAND	Good	0.7	5	3	5	5 5	5	28	S	
9742 9743	15.5 6.5	Crabapple Basswood	Ma/ us species Tilia americana	LA NDMA RK WOODLA ND	Fair Good	2T	11.5	5	5	5 2	3 4	26.5	S R	REF
9744	16	White Pine	Pinus strobus	WOODLAND	Excellent		5	5	5	5 5	4	29	R	RE
9745	6	Bassw ood	Tilia americana	WOODLAND	Good		5	4	4	5 3	4	25	R	REF
9746	7.5	Basswood	Tilia americana	WOODLAND	Good	0.7	5	4	5	5 4	4	27	R	REF
9747 9748	12 13	Black Cherry Red Oak	Prunus serotina Quercus rubra	WOODLAND WOODLAND	Good Good	2∓	5	4	3	5 5	2 4	18	R	REF
9749	9	White Pine	Pinus strobus	WOODLAND	Good		5	5	5	5 5	5	30	R	REF
9750	6	Sugar Maple	Acer saccharum	WOODLAND	Good	2∓	5	5	5	5 5	5	30	R	REF
9751	7	Black Cherry	Prunus serotina	WOODLAND	Fair		3	4	4	3 3	2	19	R	REF
9752 9753	8 10.5	Red Maple Eastern Red Cedar	Acer rubrum Junipe rus virginiana	WOODLAND WOODLAND	Good		5	5	5	5 4 5 3	5	29	R	REF
9754	10.5	Eastern Red Cedar	Junipe rus virginiana Juniperus virginiana	WOODLAND WOODLAND	Good		5	4	5	5 3	4	26	R	REF
9755	7	White Pine	Pinus strobus	WOODLAND	Good	Inner Bark Rot	5	5	5	5 3	3	26	R	REF
9756	6	White Pine	Pinus strobus	WOODLAND	Good		5	5	5	5 3	4	27	R	REF
9757	7.5 8.5	Red Oak	Quercus rubra	WOODLAND	Good		5	5	5	5 3	4	27	R	REF
9758 9759	8.5 9	Sugar Maple Quaking Aspen	Acer saccharum Populus tremulaides	WOODLAND WOODLAND	Good Good		5	5	5	5 3 5 4	5	28	R	REF
9760	6	Sugar Maple	Acer saccharum	WOODLAND	Good	2Ŧ	5	3	5	5 4	3	25	R	REF
9761	9	Black Cherry	Prunus serotina	WOODLAND	Fair		3	3	1	5 2	2	16	R	REF
9762	10	American ⊟m	Ulmus americana	WOODLAND	Good		5	3	5	5 4	3	25	R	REF
9763 9765	8	Red Maple American 目m	Acer rubrum U/mus americana	WOODLAND WOODLAND	Good Fair		5	3	5	5 4 3	5 2	18	R	REF
9766	7	White Oak	Quercus alba	WOODLAND	Good		5	5	4	5 5	5	29	R	REF
9767	6	Black Cherry	Prunus serotina	WOODLAND	Fair		3	3	4	5 3	3	21	R	REF
9768	8	Red Maple	Acer rubrum	WOODLAND	Good		5	3	5	5 4	4	26	R	REF
9769	8	Red Maple	Acer rubrum	WOODLAND	Good		5	3	5	5 4	4	26	R	REF
9770 9771	12 8	Black Cherry American 目m	Prunus serotina Ulmus americana	WOODLAND WOODLAND	Good Good		5	3	3	5 4	4	24	R	REF
9772	9.5	Sugar Maple	Acer saccharum	WOODLAND	Good		5	5	4	5 4	5	28	R	REF
9773	9	Sugar Maple	Acer saccharum	WOODLAND	Good		5	5	4	5 4	4	27	R	REF
9774	10.5	Sugar Maple	Acer saccharum	WOODLAND	Good		5	5	4	5 4	5	28	R	REF
9775 9776	8	Sugar Maple Basswood	Acer saccharum Tilia americana	WOODLAND WOODLAND	Good		5	5	4	5 4	5	28	R	REF
9777	8.5	Sugar Maple	Acer saccharum	WOODLAND	Good		5	5	4	5 3	5	27	R	REF
9778	12.5	Bassw ood	Tilia americana	WOODLAND	Good		5	5	3	5 3	3	24	R	REF
9779	7	Sugar Maple	Acer saccharum	WOODLAND	Good		5	5	5	5 4	5	29	R	REF
9780 9781	15.5 7	Black Cherry Silver Maple	Prunus serotina Acer saccharinum	WOODLAND WOODLAND	Good	3 T	5	5	3	5 4 5 3	4	26	R	REF
9782	10	Eastern Red Cedar	Juniperus virginiana	WOODLAND	Good		5	5	4	5 4	4	27	R	REF
9783	9.5	Black Cherry	Prunus serotina	WOODLAND	Poor	Fused Trunk	3	1	3	5 3	2	17	R	REF
9784	43	Sugar Maple	Acer saccharum	WOODLAND	Good	Measurement	5	5	5	5 4	5	29	R	REF
9785 9786	7.5 18	Red Oak White Pine	Quercus rubra	WOODLAND	Good	2 Ŧ	5	5	5	5 3	5	26	R	REF
9787	15.5	White Pine	Pinus strobus Pinus strobus	WOODLAND	Good Good	Z1	5	5	5	5 4	5	29	R	REF
9788	8	Black Cherry	Prunus serotina	WOODLAND	Good		5	5	5	5 4	5	29	R	REF
9789	9.5	American ⊟m	Ulmus americana	WOODLAND	Good		5	5	5	5 4	5	29	R	REF
9790	6.5	Sugar Maple	Acer saccharum	WOODLAND	Good		5	5	5	5 4	5	29	R	REF
9791 9792	9	Basswood Sugar Maple	Tilia americana Acer saccharum	WOODLAND WOODLAND	Good Good		5	5	5	5 4	5	29	R	REF
9793	10	Black Cherry	Prunus serotina	WOODLAND	Fair		5	3	3	5 3	3	29	R	REF
9794	8.5	Bassw ood	Tilia americana	WOODLAND	Excellent		5	5	5	5 3	5	28	R	REF
9795	6.5	Bassw ood	Tilia americana	WOODLAND	Fair	Leaning	5	5	5	5 3	3	26	R	REF
9796 9797	10.5 8	Sugar Maple Sugar Maple	Acer saccharum Acer saccharum	WOODLAND WOODLAND	Good Good		5	5	5	5 3	3	26 26	R	REF
9798	8	Black Cherry	Prunus serotina	WOODLAND	Fair		4	3	4	5 4	3	23	R	REF
9801	13.5	Black Locust	Robinia pseudoacacia	WOODLAND	Good		5	5	5	5 4	5	29	S	
9802	8.5	Sugar Maple	Acer saccharum	WOODLAND	Good		5	5	5	5 4	5	29	S	
9803	10	Black Locust	Robinia pseudoacacia	WOODLAND	Good		5	5	5	5 4	3	27	S	
9804 9805	16 19.5	Black Locust American ⊟m	Robinia pseudoacacia Ulmus americana	WOODLAND WOODLAND	Good Good		5	5	3	5 4	3	26	S S	
9806	11	Black Locust	Robinia pseudoacacia	WOODLAND	Good		5	5	3	5 3	3	24	S	
9807	15.5	Black Locust	Robinia pseudoacacia	WOODLAND	Good		5	5	3	5 3	3	24	S	
9808	12	Black Locust	Robinia pseudoacacia	WOODLAND	Good		5	5	5	5 3	5	28	S	
9809	10.5 7	Black Locust	Robinia pseudoacacia	WOODLAND WOODLAND	Good Good		5	5	5	5 4	5	29	S S	
9810 9811	6	Sugar Maple Common Buckthorn	Acer saccharum Rhamnus cathartica	WOODLAND	Good		5	5	5	5 4 3	3	28	S	
9812	9	Box-Elder Maple	Acer negundo	WOODLAND	Fair	Leaning	5	5	4	5 3	3	25	S	
9813	9	American ⊟m	Ulmus americana	WOODLAND	Good		5	5	4	5 4	5	28	S	
9814	9	American ⊟m	Ulmus americana	WOODLAND	Poor		3	3	3	5 3	2	19	S	
9815	6.5 9	Box-Elder Maple	Acer negundo	WOODLAND	Good		4 5	5	4	5 4 5 3	3	25 25	S	
9816 9817	9	Box-⊟der Maple Box-⊟der Maple	Acer negundo Acer negundo	WOODLAND WOODLAND	Good Good		5	5	4	5 3 5 4	5	25	S R	REF
9818	7.5	Sugar Maple	Acer saccharum	WOODLAND	Good		5	5	3	5 4	3	25	R	REF
9819	9.5	Box-⊟der Maple	Acer negundo	WOODLAND	Fair	Choked By Vines		3	3	5 3	3	22	R	REF
9820	6	Common Buckthorn	Rhamnus cathartica	WOODLAND	Good		5	5	4	5 4	4	27	R	REF
9821 9822	7 11.5	Box-⊟der Maple American ⊟m	Acer negundo Ulmus americana	WOODLAND WOODLAND	Good Good		5	5	4	5 4	4	27	S	
9823	8	Box-Elder Maple	Acer negundo	WOODLAND	Good		5	5	4	5 4	4	27	S	
9824	7	Box-⊟der Maple	Acer negundo	WOODLAND	Fair		4	5	4	5 3	3	24	S	
	8	Black Cherry	Prunus serotina	WOODLAND	Good		5	5	4	5 3	3	25	S	
9825														

TAG	DBH	COMMON NAME	LATIN NAME	CLASS	CONDITION	COMMENTS	CONDITION/ FACTOR					OVERALL	SAVE /		
NO.							trunk	growth rate	structure	insects/ diseases	crown dev	life exp.	RANK	REMOVE	REPLACE
9851	11.5	Sugar Maple	Acer saccharum	WOODLAND	Good		5	5	5	5	4	5	29	S	-
9852	13	Black Cherry	Prunus serotina	WOODLAND	Good		5	5	4	5	4	4	27	S	-
9853	12	Sugar Maple	Acer saccharum	WOODLAND	Good		5	5	5	5	4	5	29	S	-
9854	9	Sugar Maple	Acer saccharum	WOODLAND	Good		5	5	5	5	4	5	29	S	-
9855	7	Sugar Maple	Acer saccharum	WOODLAND	Good		5	5	5	5	4	5	29	S	-
9856	13.5	Black Cherry	Prunus serotina	WOODLAND	Good	3T	4	5	4	5	4	4	26	s	-
9857	6.5	Black Cherry	Prunus serotina	WOODLAND	Fair		4	3	3	5	3	2	20	S	-
9893	6	Sugar Maple	Acer saccharum	WOODLAND	Good		5	5	5	5	4	5	29	S	-
9894	8	Black Locust	Robinia pseudoacacia	WOODLAND	Poor		2	3	4	1	3	2	15	S	-
9895	7.5	Black Locust	Robinia pseudoacacia	WOODLAND	Good		5	3	4	5	3	4	24	s	-
9896	7	Sugar Maple	Acer saccharum	WOODLAND	Good		5	5	5	5	4	5	29	s	-
9897	6	Sugar Maple	Acer saccharum	WOODLAND	Good		5	5	5	5	4	5	29	S	-
9898	7	Black Locust	Robinia pseudoacacia	WOODLAND	Poor		2	1	3	5	1	2	14	S	-
9899	14	Black Locust	Robinia pseudoacacia	WOODLAND	Good		5	5	3	5	3	5	26	S	-
9999	11	Sugar Maple	Acer saccharum	WOODLAND	Good		5	5	5	5	4	4	28	S	-
10000	7	Sugar Maple	Acer saccharum	WOODLAND	Fair		5	3	5	5	2	3	23	S	-








CAUTION!!

THE LOCATIONS AND ELEVATIONS OF EXISTING UNDERGROUND UTILITIES AS SHOWN ON THIS DRAWING ARE ONLY APPROXIMATE. NO GUARANTEE IS EITHER EXPRESSED OR IMPLIED AS TO THE COMPLETENESS OR ACCURACY THEREOF. THE CONTRACTOR SHALL BE EXCLUSIVELY RESPONSIBLE FOR DETERMINING THE EXACT UTILITY LOCATIONS AND ELEVATIONS PRIOR TO THE START OF CONSTRUCTION.

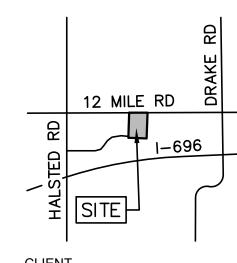

CUNNINGHAM LIMP COMPANY 28970 CABOT DR, STE. 100 NOVI, MI 48377

PROJECT TITLE

TLE
FARMINGTON
HILLS
12 MILE ROAD & INVESTMENT DRIVE
FARMINGTON HILLS, OAKLAND COUNTY, MI

REVISIONS ENGINEERING SUBMITTAL II 05-02-25 SIDEWALK/DUMPSTER SKETCH 05-30-25 SITE PLAN RESUBMITTAL 06-06-25

DRAWING TITLE

ORIGINAL ISSUE DATE: FEBRUARY 21, 2025

EXISTING TREE LIST

PEA JOB NO. 24-0991 JRH CAL JLE DES.
DRAWING NUMBER:



DATE: July 10, 2025

TO: Planning Commission

FROM: Erik Perdonik, AICP, City Planner

SUBJECT: Adoption of Amended Bylaws and Rules of Procedure

Consideration of adoption of the attached amended Planning Commission Bylaws and Rules of Procedure is on your agenda tonight to clarify what has long been a source of confusion.

As you know, the Planning Commission meets just once per month on the third Thursday of each month with some exceptions, such as the January meeting dedicated to the Capital Improvements Plan.

However, per the current Bylaws and Rules of Procedure, the City's meeting schedule, which is accessible via the City's website, shows Planning Commission meetings scheduled for the second, third, and fourth Thursday of each month.

Unfortunately, this has led both external observers, such as the public and applicants, and internal observers, such as the Mayor and members of City Council, to believe that we are cancelling a high number of meetings, even though two (2) such meetings each month were never intended to be held. Moreover, based upon the schedule, applicants are often under the impression that they can pick which of the three (3) meetings they wish to have their application considered at, which is not the case.

It is in this light that staff is simply requesting that the Bylaws and Rules of Procedure be amended to reflect the reality of the Planning Commission's schedule so as not to lead to unrealistic expectations. We cannot remove the additional regular meetings from the schedule that are causing the confusion until such time that the Bylaws and Rules of Procedure are amended to be consistent with the actual schedule, which is to meet regularly only once per month, generally on the third Thursday.

Note that this does not tie our hands in terms of moving meeting dates, as meetings apart from the third Thursday of the month would simply be scheduled as a special meeting at which the Planning Commission may conduct any business.

The attached resolution would need to be adopted by the Planning Commission to begin the process of effectuating the change described above, and the revisions would then go before City Council for final approval.



ATTACHMENTS:

- Draft amended Bylaws and Rules of Procedure with changes shown in red
- Draft Resolution R-PC-1-25 to adopt revised Bylaws and Rules of Procedure

City of Farmington Hills, Michigan

PLANNING COMMISSION BYLAWS AND RULES OF PROCEDURE

PREAMBLE

The Planning Commission of the City of Farmington Hills was created by Section 3.11 of the City Charter, which became effective July I, 1973. As constituted by the Charter, the Commission consists of nine (9) members possessing the qualifications required by the Charter for elected officials. They are appointed and removed by the Mayor, subject to the approval of the Council, and their compensation is determined by the Council.

The Planning Commission exercises duties as provided by applicable state planning laws and City of Farmington Hills City Code, Chapter 21, Article II. The following Bylaws and Rules of Procedure are adopted pursuant to City Code Sections 2-141 and 21-32 and applicable state planning laws. They are intended to provide a means whereby the duties conferred upon the Commission may be effectively exercised. The rules recited herein shall not be construed so as to conflict with the Farmington Hills City Code or the laws of the State of Michigan.

ARTICLE I. OFFICERS

- 1. The Commission shall have a Chair, Vice Chair, and Secretary, who shall be chosen by a vote of the majority of the Commission within thirty (30) days of after the Mayor's and/or City Council's annual appointments or re-appointments of members of the Planning Commission. The term of each officer shall be one (l) year, with eligibility for reelection, except that a member shall not be eligible to serve more than two (2) successive terms as Chairperson. In the event of a vacancy in any office, an election to fill such vacancy for the remainder of the term shall be held as soon as possible. If the election results in a vacancy of another office, that office shall be filled at the same election.
- 2. The Chair shall preside at all meetings, shall appoint such committees as are from time to time deemed necessary, and shall perform such duties as may be delegated to the Chair by the Commission. The Chair shall have a vote on all resolutions and matters before the Commission.
- 3. The Vice Chair shall preside in the absence of the Chair.
- 4. The Secretary shall stamp or certify approved plans and shall sign the approved agenda and minutes. If a recording secretary is not present at a meeting of the Commission, the Secretary shall keep a record of the minutes of all meetings and of all transcripts, documents, plans, etc., brought before the Commission at such meeting.

5. The Commission may create and fill such other offices or committees as it finds necessary to effectuate the lawful purposes for which it was created.

ARTICLE II. MEETINGS

- l. Regular meetings shall—generally be scheduled on the first, second, and/or third Thursday of each month, as necessary, at 7:30 p.m. at City Hall. All scheduled meetings shall be considered regular meetings.
- 2. The schedule of meetings may be amended (including canceling a meeting) by resolution of the majority of the members of the Commission. Notice of such amended schedule shall be given to the public by written notice posted in accordance with the Open Meetings Act, Act 267 of 1976, as amended, and applicable planning laws.
- 3. A special meeting may be called by the Chair, or upon request of three (3) members, provided forty-eight (48) hours notice has been given to each member of the Commission and to the public. Notice to the public shall be as is provided in the Open Meetings Act and applicable planning laws. Such notice shall include the reasons for which this special meeting is called.

<u>ARTICLE III. VOTING AND ORDER OF BUSINESS</u>

- 1. The Planning Commission may act at regular or special meetings. A meeting shall not be called to order until a quorum of the members is present. A quorum shall consist of five (5) members of the Planning Commission and an affirmative majority vote of members present shall be necessary to pass any motion.
- 2. All meetings shall be open to the public. In the event there is a formally scheduled public hearing on any specific agenda item, then any member of the public shall be given an opportunity to be heard on any relevant matter concerning the subject of the hearing. The opportunity of each member of the public to be heard on any matter scheduled for public hearing shall be limited to a time of three (3) minutes, unless this time is extended by the Chair or by vote of a majority of the Commissioners present. No member of the public shall speak twice on any subject matter unless authorized by the Chair.
- 3. The order of business at Commission meetings shall be as follows:
 - a. Roll Call
 - b. Approval of Agenda
 - c. Unfinished Business
 - d. New Business
 - e. Approval of Minutes
 - f. Public Comment
 Commissioner Comment
 - h. Adjournment

4. The meetings will be conducted as follows:

Rezoning Request/Plats/Cluster Site Plans/Site Condominiums/PUD/ Special Approvals

- 1. The case will be called by the Chair.
- 2. The proponent and/or representative(s) will introduce the request.

Ten (10) minute maximum on rezoning request.

Twenty (20) minute maximum on all other items.

- 3. Consultant/staff will review request.
- 4. Planning Commission members may question proponent and staff.
- 5. Public Hearing (if required).

Members of the public who wish to speak on the item being considered will be called on by the Chair and should give their name and address to the recording secretary. The public shall address the Commission and shall not engage in direct dialogue with the proponent.

Time Limit

Individuals: Three (3) minutes each

Group Representative (i.e., Homeowners Asso.): Five (5) minutes each

- 6. The public hearing is closed.
- 7. The proponent has the opportunity to respond and/or comment on public input to the Commission, maximum two (2) minutes.
- 8. The matter is then considered by the Planning Commission.

Site Plans/Landscape Plans/Lot Splits

- 1. Consultant/staff reviews the request with the Commission.
- 2. The proponent and/or representative(s) review the request with the Commission.
- 3. The Commission questions consultant/staff and the proponent/representatives.
- 4. The matter is then considered by the Planning Commission. NOTE: No public hearing is required.
- 5. Committee reports shall be submitted to the Planning Commission at its study sessions.

- 6. All proceedings, decisions, and resolutions of the Commission shall be initiated by motion. The vote upon the motions and resolutions shall be recorded.
- 7. The Commission shall keep a public record of its resolutions, transactions, findings and determinations, in the office of the City Clerk.
- 8. For all questions of procedure not addressed by these Bylaws and Rules of Procedure, Roberts . Rules of Order Newly Revised shall govern to the extent reasonably possible.
- 5. No member of the Planning Commission may vote on any issue in which he or she may reasonably be considered to have a conflict of interest. If a member could reasonably be considered to have such a conflict of interest pertaining to a matter that is to be addressed by the Planning Commission, the member shall disclose the potential conflict of interest to the Planning Commission before participating in any discussion or casting a vote on such a matter. Unless the Planning Commission concludes, upon a majority vote of the remaining members, that the member's participation does not constitute a conflict of interest and that his or her participation and vote will not be affected by his or her interest, the member shall leave his or her seat and the dais or meeting table and shall abstain from discussion and voting on the matter. A member shall not appear before the Planning Commission as an advocate in relation to any matter in which he or she has abstained for reasons of conflict of interest. For purposes of these bylaws, a "conflict of interest" exists when a member of the Planning Commission or a member of his or her family has a proprietary or financial interest in an issue or matter that is before the Planning Commission beyond that which is experienced by the public in general, or the member may receive or gain a financial benefit as a result of a vote on such issue or matter, or which would result in a violation of Section 10.01 of the City Charter, the City of Farmington Hills Code of Ethics, the Incompatible Public Offices Act, 566 PA 1978 (MCL 15.181 et. seq.), or any other state law or city charter, ordinance, ethics code or policy provision applicable to city officials and conflicts of interest. Failure to disclose a conflict of interest a required by this subsection constitutes malfeasance in office.

ARTICLE IV. REPORTS TO THE CITY COUNCIL

- 1. From time to time, the Planning Commission may, through the Chair, make such reports and/or recommendations to the City Council as it may deem necessary to effectuate the lawful purposes for which it was established. The Planning Commission shall file at least one annual report with the City Council, in accordance with the requirements of applicable state planning laws.
- 2. In fulfilling its designated duties under City ordinance and state law, the Planning Commission shall not exceed the appropriations authorized to it by the Council.

ARTICLE V. AMENDMENTS

- 1. Amendment of these Bylaws and Rules of Procedure shall be, by resolution of the Planning Commission, passed at any meeting called for that purpose. A resolution to amend the Bylaws and Rules of Procedure shall require an affirmative vote of a 2/3 majority of the members of the Commission.
- 2. A resolution to suspend the Bylaws and Rules of Procedure shall require an affirmative vote of a 2/3 majority of the members present and voting.

Adopted by Planning Commission	
Approved by City Council	

CITY OF FARMINGTON HILLS COUNTY OF OAKLAND STATE OF MICHIGAN

RESOLUTION OF THE CITY OF FARMINGTON HILLS PLANNING COMMISSION ADOPTING REVISED BYLAWS AND RULES OF PROCEDURE

RESOLUTION NO. R-PC-1-25

At a City of Farmington Hills Planning Commission regular meeting held on the 17^{th} day of July 2025, at 7:30 p.m., with those present and absent being:

PRESENT:
ABSENT:
The following preamble and resolution were offered by Commissioner and supported by Commissioner
WHEREAS , pursuant to Chapter 2, Article IV, Division 1 of the City of Farmington Hills City Code, all appointed boards, commissions, and councils shall adopt bylaws for the transaction of business, and regularly review their bylaws to ensure that they are consistent with existing laws, ordinances and practices; and
WHEREAS , the Planning Commission has reviewed its bylaws and rules of procedure and has concluded that it is necessary and desirable to adopt the revised Planning Commission Bylaws and Rules of Procedure attached to this resolution; and
WHEREAS , City of Farmington Hills Code Section 2-141 requires that bylaws and bylaws amendments be adopted by a 2/3 vote of the Planning Commission, and subsequently presented to the City of Farmington Hills City Council for review and approval before becoming effective.
NOW, THEREFORE, BE IT RESOLVED that the attached Planning Commission Bylaws and Rules of Procedure are hereby adopted; and
BE IT FURTHER RESOLVED that a copy of this resolution and the attached Planning Commission Bylaws and Rules of Procedure be forwarded to the City Council of the City of Farmington Hills for review and approval.
AYES: NAYS: ABSTENTIONS: ABSENT:
RESOLUTION DECLARED ADOPTED JULY 17, 2025.

STA	ATE OF MIC	HIGAN)	20								
CO	UNTY OF O	AKLAND)	SS.								
of (Dakland, Sta a resolution	ned, the duly ate of Michig adopted by In the 17 th da	an, the	do he Plann	reby certify ing Commi	/ that ssion	the of t	foregoin he City o	g is a true f Farmingto	and con	nplete at a re	copy
IN of_		WHEREOF, _ 2025.	Ι	have	hereunto	set	my	official	signature,	this _		day
							Carly Hills	Lindahl,	City Clerk,	City of	Farm	 ington

DRAFT

MINUTES PLANNING COMMISSION SPECIAL MEETING CITY OF FARMINGTON HILLS COMMUNITY ROOM June 19, 2025, 6:00 P.M.

CALL MEETING TO ORDER

The Planning Commission Special Meeting was called to order by Chair Trafelet at 6:10pm.

ROLL CALL

Commissioners present: Brickner, Countegan, Mantey, Stimson, Trafelet, Varga, Ware

Commissioners Absent: Aspinall, Grant

Others Present: Staff Planner II Mulville-Friel, City Attorney Schultz, Planning

Consultants Bahm, and Upfal

APPROVAL OF AGENDA

MOTION by Countegan, support by Stimson, to approve the agenda as published. Motion passed unanimously by voice vote.

SPECIAL MEETING

A. <u>CONTINUED DISCUSSION OF DRAFT ZONING TEXT AMENDMENT 6, 2024, TO ADD PROVISIONS REGARDING PUBLIC ART</u>

Background

Planning Consultant Bahm led this continued discussion of draft Zoning Text Amendment 6, 2024, based on her April 9, 2025 memorandum *Draft Arts Ordinance*, the revised draft of the Zoning Text Amendment distributed this evening, and referencing the May session where initial comments and questions were raised about the draft amendment.

Consultant Bahm identified several key revisions and considerations in the revised draft:

- Clarified how the site plan review process intersects with public art requirements, and emphasizing that the process not slow down the overall approval process.
- Added examples of acceptable artistic elements including environmental artworks, functional items (bike racks, benches, light fixtures).
- Edited portions of the ordinance for clarity and consistency.
- Explained that applicants may proceed through site plan review before finalizing art selection, but must show proposed art placement on the plan to ensure it meets location requirements.
- Final placement and installation details are to be reviewed by the City Planner and Building Official.
- Updated procedures will require applicants to submit an updated project construction budget when applying for building permits, which will then determine the public art contribution.

Planning Consultant Bahm also suggested a potential exemption for fully residential projects that are non-subsidized and priced affordably for residents earning less than 120% of the area median income. Commissioner Mantey questioned whether such projects currently exist and what their market value would be. Bahm estimated the average income to be around \$100,000, equating to an approximate home price of \$300,000–\$360,000. However, both Commissioners Mantey and

Stimson noted that most recent residential developments were priced above \$500,000 and would thus not qualify for exemption.

Commission discussion

Planning Commission discussion focused on geographic targeting, practical implementation, and proportionality based on parcel size and redevelopment scale.

Commissioner Stimson pointed out that Section 3.C. mentions review by the Arts Commission prior to site plan approval, but this conflicts with Section 3.B.'s timeline, which places the budget update after approval. Bahm clarified that Arts Commission review should occur after site plan approval; this would be corrected.

Commissioner Mantey compared the proposed arts ordinance to the tree ordinance, where developers either replace trees or contribute to a fund. He asked if exemptions should be eliminated in favor of always requiring a payment into an art fund.

It was pointed out that unlike the tree fund, the art requirement is not tied to replacing a removed asset, making the justification for the fund different.

Commissioner Ware raised concerns about the affordability and feasibility of requiring public art in residential projects, especially those initiated by individual property owners rather than large-scale developers. She emphasized the financial burden this might place on smaller building or renovating projects, especially in less affluent contexts.

Planning Consultant Bahm responded that the threshold in the current draft targets projects over \$2 million, and whether undertaken by a resident or developer, the financial investment would be equivalent. Ware said that the source of funding—personal versus corporate—matters significantly for individual developers. Also, art in subdivisions would ultimately become the responsibility of the homeowners association, and HOAs currently struggled with accumulating enough funding to deal with basic maintenance projects.

Commissioner Mantey estimated the added cost of compliance might be relatively minor in large projects, but emphasized the importance of fairness in who bears the cost. Commissioner Stimson clarified that the ordinance applies to developments with four or more residential units, not single-family homes.

Commissioner Brickner was opposed to applying the public art requirement in residential areas, including both small and large subdivisions. Subdivisions often have limited space for public art and such requirements could reduce housing density. He supported limiting requirements to commercial, office, or large-scale multi-family projects where placement of art in public or visible spaces is more appropriate.

Consultant Upfal asked whether subdivision recreation areas could host art installations, but Commissioners Brickner and Ware emphasized that not all subdivisions have such areas or the financial capacity to maintain them. Imposing art requirements adds costs that may not align with community priorities.

Commissioner Countegan said that any new ordinance that imposes additional costs will ultimately affect future residents and developers. He urged the Commission to consider whether these costs translate into real community value. He favored incentivizing public art—via density bonuses or landscaping trade-offs—rather than mandates, and emphasized the importance of maintaining essential services to attract desirable development.

Commissioner Countegan pointed out that the Planning Commission's role was to establish a thorough record of deliberation and provide a well-considered recommendation to City Council.

Commissioner Varga summarized two unresolved issues: the treatment of residential projects and the broader question of exemptions. She suggested tailoring the ordinance to distinguish between large-scale residential developers and smaller residential builders, possibly using density or size as the determining metric rather than a flat \$2 million threshold.

Commissioner Countegan was concerned that requiring art in residential areas could conflict with residents' desire for privacy, and again advocated for incentivizing rather than mandating public art in these contexts. Public art could be tied to other ordinance provisions, such as landscaping tradeoffs, or offered as a negotiated benefit in Planned Unit Developments (PUDs). Commissioner Countegan emphasized that the art requirement should apply only in areas where public interaction was likely.

Commissioner Ware emphasized that the original intent behind public art provisions during the master planning process was to place art in public areas, such as major roads or parks, not in residential neighborhoods. She supported having developers contribute to a city-managed public art fund instead of installing art within subdivisions, thereby allowing the City to determine appropriate, high-impact locations for public art. When part of a PUD, public art could be negotiated as part of the public benefit package.

Discussion focused on exemptions (Section 6). Should projects that fall under exemptions be required to contribute a lesser amount rather than nothing at all? Planning Consultant Bahm noted that the proposed structure mirrors Southfield's ordinance, which also uses a four-unit threshold and a half-percent requirement.

Commissioner Countegan supported promoting public art through flexibility and options, such as trading density or landscaping requirements, to avoid discouraging development. He cautioned against rigid financial demands that could prompt developers to seek alternative locations outside of Farmington Hills. Planning Consultant Bahm responded that Farmington Hills is a desirable community and should consider adopting public art as part of its identity, especially in prominent commercial corridors. She pointed to PUDs such as Hunter Square as examples where the city could consider public art installations alongside other amenities like bus shelters and high-quality design features.

Commissioner Varga supported requiring contributions to an art fund when developers receive increased density through PUDs. Public art requirements should be viewed as a way for developers to invest in the community when receiving extra allowances or being allowed to deviate from

ordinance requirements.

City Attorney Schultz suggested including public art contributions as one of several potential public benefits in PUDs, rather than as a mandatory provision.

Commissioner Stimson asked how often Southfield's ordinance results in contributions to a fund versus onsite installations.

Commissioner Countegan emphasized aligning the ordinance with the Master Plan by identifying specific areas—rather than entire zoning districts—as appropriate for public art. He supported focusing investment and installations along corridors such as 12 Mile Road, Orchard Lake Road, and within redevelopment zones designated in the Master Plan, including right-of-way areas where visibility is high and traffic counts are significant. He reiterated that incentivizing art, rather than mandating it universally, would be more effective. Mandated payments might burden small business owners with limited budgets. He encouraged the Commission to consider flexibility and fairness.

Planning Consultant Bahm summarized that multiple commissioners supported focusing installations along high-profile corridors such as Orchard Lake Road, 12 Mile Road, Northwestern Highway, and possibly Grand River and 8 Mile Road. Commissioner Brickner suggested starting with these target corridors before considering broader implementation. Commissioner Stimson expressed support for extending the art requirement beyond the main corridors.

Planning Consultant Bahm noted that some of these areas, particularly Grand River and 8 Mile, are made up of smaller parcels, making it more difficult for individual owners to meet public art requirements. She suggested these areas should be prioritized for fund expenditure rather than required to host art directly. Commissioner Countegan advocated for creating thematic installations based on corridor characteristics (e.g., automotive themes on 8 Mile).

The Commission discussed adjusting the threshold or contribution rate based on location and investment size, suggesting a lower rate for smaller-scale developments on Grand River and 8 Mile, or a higher threshold, before triggering the requirement. Discussion reinforced the need for a flexible approach, including developing policies that reflects where art makes sense within the city's broader vision.

Commissioner Mantey pointed out the reference to the Consumer Price Index (CPI). He recommended that the ordinance specify the "CPI for All Urban Consumers" and suggested use of an annual CPI from a known base year (e.g., 2004) to avoid ambiguity in future calculations.

Planning Consultant Bahm clarified that the request for the ordinance originated with City Council, which supports the public art provision and initially focused on PUDs before broadening the scope.

There appeared to be consensus to retain flexibility to approve exemptions on a case-by-case basis.

Commissioner Countegan supported a centralized approach to placing public art, emphasizing strategic investment in focal points accessible to the public. He expressed concern that scattered installations could become maintenance burdens and fail to create meaningful impact.

Commissioner Stimson responded that where on-site installation was impractical, payments into the art fund would allow the City to place artwork in appropriate public spaces. He also noted that if contributions were limited to major corridors, the art fund would remain underfunded. Including areas like Middlebelt would increase fund revenue, enabling placement of public art in preferred locations.

Planning Consultant Bahm said she would revise the draft ordinance based on tonight's discussion, and the Planning Commission would have another study session on this issue.

PUBLIC COMMENT

None.

COMMISSIONER COMMENTS

Commissioner Mantey shared that he had attended a strategic branding session and appreciated the inter-commission collaboration it provided. He recommended future cross-commission exchanges to promote city-wide coordination.

Commissioner Brickner spoke to the ongoing work on Orchard Lake Road between 12 Mile and 13 Mile Roads.

ADJOURNMENT

MOTION by Mantey, support by Ware, to adjourn. Motion carried unanimously by voice vote.

The meeting adjourned at 7:20pm.

Respectfully Submitted, Kristen Aspinall Planning Commission Secretary

/cem

CITY OF FARMINGTON HILLS PLANNING COMMISSION MEETING 31555 W ELEVEN MILE ROAD FARMINGTON HILLS, MICHIGAN JUNE 19, 2025, 7:30 P.M.

CALL MEETING TO ORDER

The Planning Commission Regular Meeting was called to order by Chair Trafelet at 7:30 p.m.

ROLL CALL

Commissioners present: Brickner, Countegan, Mantey, Stimson, Trafelet, Varga, Ware

Commissioners Absent: Aspinall, Grant

Others Present: Staff Planner II Mulville-Friel, Planning Consultant Upfal (Giffels

Webster), City Attorney Schultz

APPROVAL OF THE AGENDA

MOTION by Countegan, support by Mantey, to approve the agenda as published. Motion passed unanimously by voice vote.

PUBLIC HEARING

A. ZONING TEXT AMENDMENT 5, 2024

CHAPTER OF CODE: 34, Zoning Ordinance PROPOSED AMENDMENT: Add design standards

ACTION REQUESTED: Recommendation to City Council

SECTION: new Section 34-5.20

Planning Consultant Upfal introduced the proposed amendment to add design standards to the Zoning Ordinance, noting that this topic had been discussed and reviewed in two prior study sessions. The objective of the amendment is to establish a baseline for building quality and appearance, emphasizing durability, maintainability, and consistency with the City's aesthetic vision, while balancing flexibility for developers.

Key elements of the proposed standards include:

- Applicability: Applies to all new construction. For expansions, applies only when there is a 50% or
 greater increase in floor area or indoor seating capacity, and only to facades facing or oriented
 toward a public right-of-way. Single and two-family dwellings are exempt, and in LI-1 zoning
 districts, the standards apply only on major thoroughfares.
- Building Materials: Specifies permitted primary and accent materials. At least 60% of the facade
 must use primary materials. This threshold is considered flexible compared to requirements in other
 communities.
- **Waivers:** The Planning Commission may grant waivers to the building material requirements if the two defined findings in 4.g. are met.
- Architectural Scaling: Prohibits blank facades and requires variation and articulation on visible facades facing public rights-of-way.

- Roof Standards: Flat roofs must include parapets to conceal HVAC equipment; pitched roofs must meet slope requirements, with waivers available. Rooftop patios/terraces on buildings three stories or more are prohibited in the rear 35% of lot depth.
- **Fenestration:** Specifies minimum ground and upper floor fenestration for buildings facing major thoroughfares and other public rights-of-way, with exceptions for uses requiring privacy.
- **Entrances:** Removes the mandate for front-facing entrances, instead requiring defined entrance features.

Commission discussion:

Discussion included the following key points and questions:

- One intent of the proposed design standards is to discourage poor-quality, low-cost construction, ensuring a baseline level of architectural integrity and material durability.
- Commissioners were concerned as to whether developers or the Chamber of Commerce had been notified of tonight's public hearing. In any event, community stakeholders should be notified before this amendment is presented to City Council.
- The draft referenced the "Zoning Administrator" as someone who reviews building facades, but the City does not use this title. The designation will be updated to "City Planner."
- It was suggested that 4.c. be edited to read: "... labeled on the proposed building elevation plans."
- Site plan informational requirements might need to be updated to require elevation drawings.
- A request was made to add a provision allowing additions to existing buildings to use the same
 materials as the original structure. Planning Consultant Upfal explained that the current draft
 requires full facade compliance if expansion exceeds 50%. Discussion focused on whether requiring
 such full compliance discourages redevelopment. Concerns were raised about forcing developers to
 update entire facades when expanding a building slightly beyond 50%. It was suggested that such
 strict compliance requirements might prevent some redevelopment or discourage reasonable
 building expansions.
- Planning Consultant Upfal clarified that additions under 50% are exempt from the standards, but that additions exceeding 50% must bring the entire visible facade into compliance. Commissioners debated the merits of adding an exception that would allow existing materials to be reused on expansions for design continuity.
- City Attorney Schultz pointed out that the ordinance intentionally requires buildings undergoing
 expansions over 50% to bring the visible facade into compliance with new standards. This was
 designed to improve outdated or lower-quality construction. For expansions under 50%, only the
 new or modified elements must comply. Additionally, the ordinance includes a general waiver
 provision that allows flexibility when existing materials may still be appropriate.
- Questions were raised about whether the requirement for parapets to screen rooftop mechanical
 units is redundant, as existing ordinances already require such screening. Planning Consultant Upfal
 suggested eliminating that requirement, but retaining the requirement that limited parapet height
 to one third of the height of the supporting wall (6.a.i.).
- A broader concern was raised about the assumption that using preferred materials would prevent blight. Even buildings made with approved materials can become eyesores if poorly maintained, while other materials might still result in attractive, well-kept buildings.
- Commissioner Countegan was concerned about placing financial strain on small businesses seeking
 to invest in modest improvements. He argued that cost-effective, code-compliant materials should
 remain an option, and that inflexible requirements might deter reinvestment.

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- City Attorney Schultz reiterated that the waiver provision exists specifically to address concerns about high costs for required materials during redevelopment or renovation.
- There appeared to be consensus that the Commission should retain case-by-case discretion through the waiver process rather than creating an automatic exemption. It was up to developers to provide financial or practical reasoning in support of waiver requests.
- A final concern was that routine maintenance projects could inadvertently trigger the ordinance's requirements if more than 50% of the facade was affected. It was pointed out that any project that involved more than 50% of a façade would constitute a significant investment and would likely not be considered basic maintenance.
- Commissioner Brickner suggested revising 8.e. to include "exterior artwork" as an encouraged entryway feature.

Chair Trafelet opened the public hearing. As no public was present, Chair Trafelet closed the public hearing and brought the matter back to the Commission for further discussion and/or a motion.

MOTION by Mantey, support by Stimson, to recommend approval of Zoning Text Amendment No. 5-2024 to City Council, with the following revisions:

- Section 4.c.: "All building materials and colors shall be clearly labeled on the proposed <u>building</u> elevation plans."
- Section 4.d: Replace "Zoning Administrator" with "City Planner."
- Section 6.a.i.: Eliminate first sentence.
- Section 8.e.: Add "exterior artwork" after "benches" in the list of entryway feature examples.

Motion passed unanimously by voice vote.

REGULAR MEETING

No items.

APPROVAL OF MINUTES May 15, 2025, Regular and Special Meetings

MOTION by Brickner, support by Ware, to approve the May 15, 2025 Regular and Special Meeting minutes as submitted.

Motion passed unanimously by voice vote.

PUBLIC COMMENT

None

COMMISSIONER/STAFF COMMENTS

Commissioner Brickner spoke regarding the ongoing construction on Orchard Lake Road between 12 and 13 Mile Roads.

ADJOURNMENT

MOTION by Ware, support by Brickner, to adjourn the meeting. Motion passed unanimously by voice vote.

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The meeting ended at 8:05pm.

Respectfully submitted, Kristen Aspinall, Planning Commission Secretary